

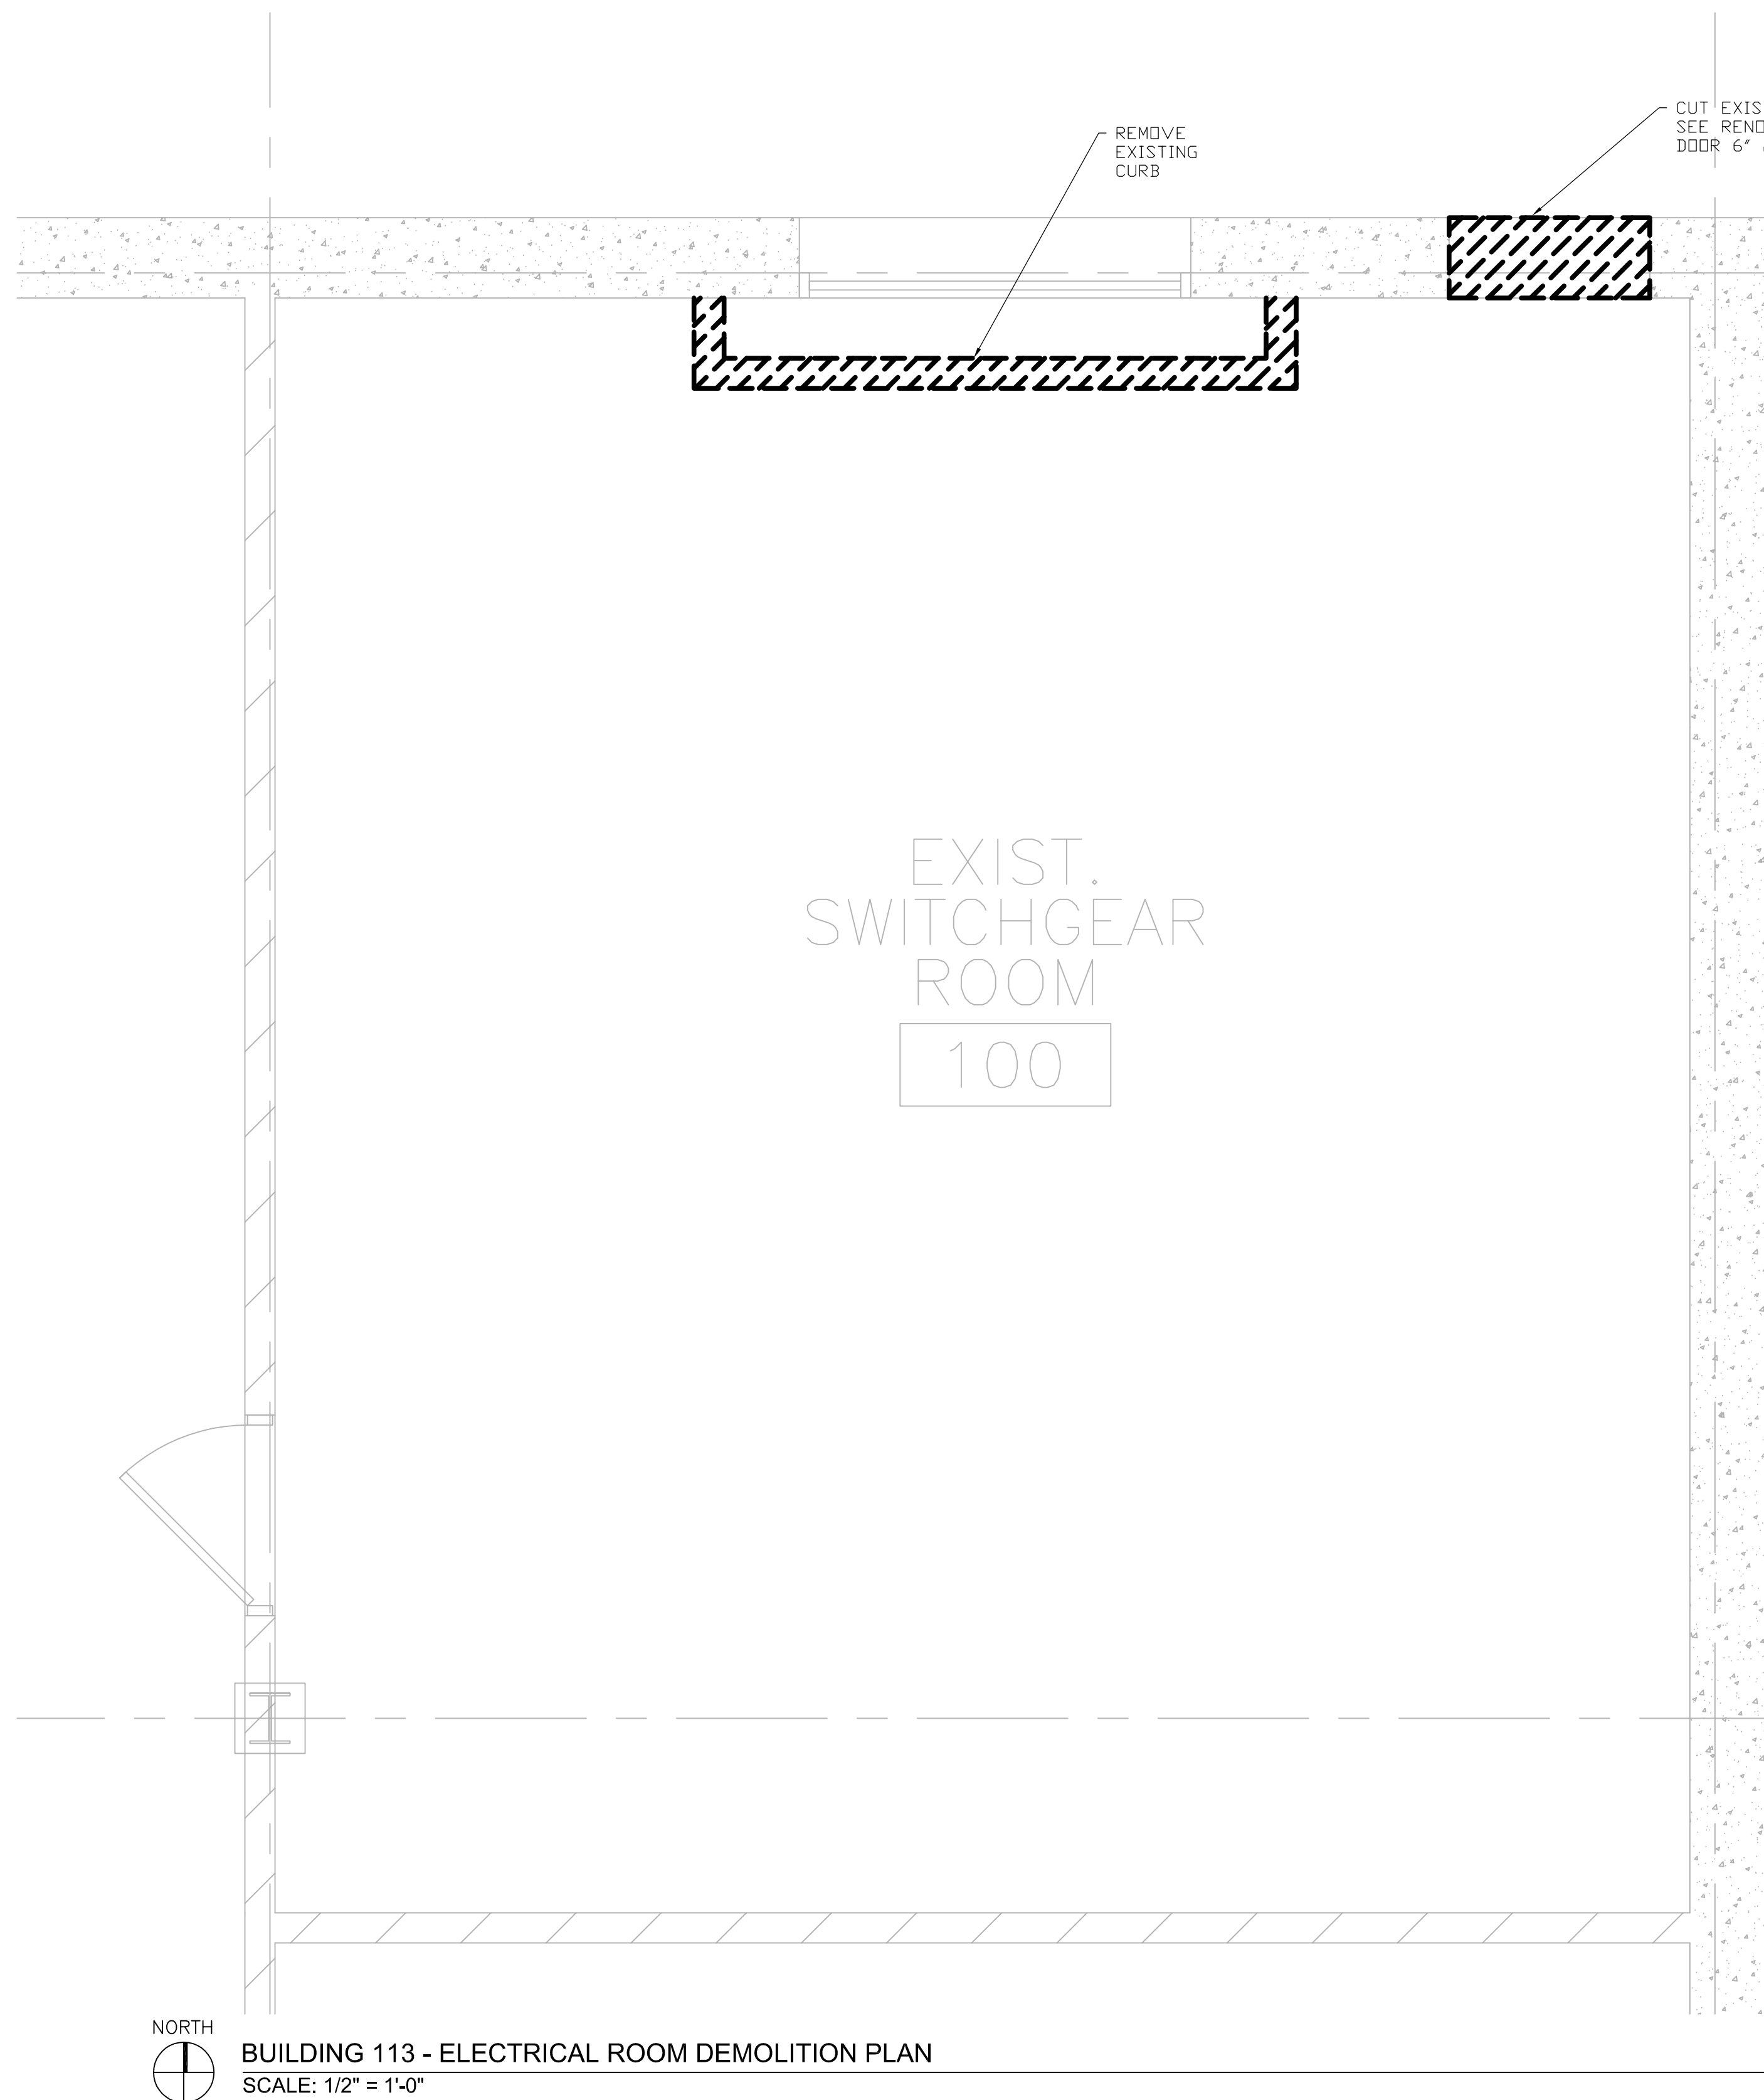


DOOR SCHEDULE																
DOOR NO. ROOM NO. ROOM NAME			DOOR						FRAME					HARDWARE GROUP ASSEMBLY RATING DOOR SCHEDULE REMARKS		
			SIZE		TYPE	MATERIAL	FINISH	GLASS TYPE	SIZE		TYPE	MATERIAL	FINISH			
			WIDTH	HEIGHT					WIDTH	HEIGHT						
GROUND FLOOR																
100.1	100	EQUIPMENT ROOM	3'-0"	7'-0"	A	STEEL	P-1	---	3'-0"	7'-0"	HM-1	STEEL	P-2	HW-E4		1, 2, 3
DOOR SCHEDULE REMARKS: 1.) DOOR TO BE PROVIDED w/ EMERGENCY EGRESS AND PANIC HARDWARE. SEE DOOR HARDWARE SPECIFICATIONS. 2.) SEE DIVISION 26 (ELECTRICAL) FOR ALL ELECTRICAL HARDWARE CONNECTIONS AND REQUIREMENTS. 3.) DOOR TO BE EQUIPPED WITH CARD ACCESS READER. SEE ELECTRICAL DRAWINGS FOR ALL DOOR HARDWARE CONNECTIONS AND REQUIREMENTS.																

GENERAL NOTES:

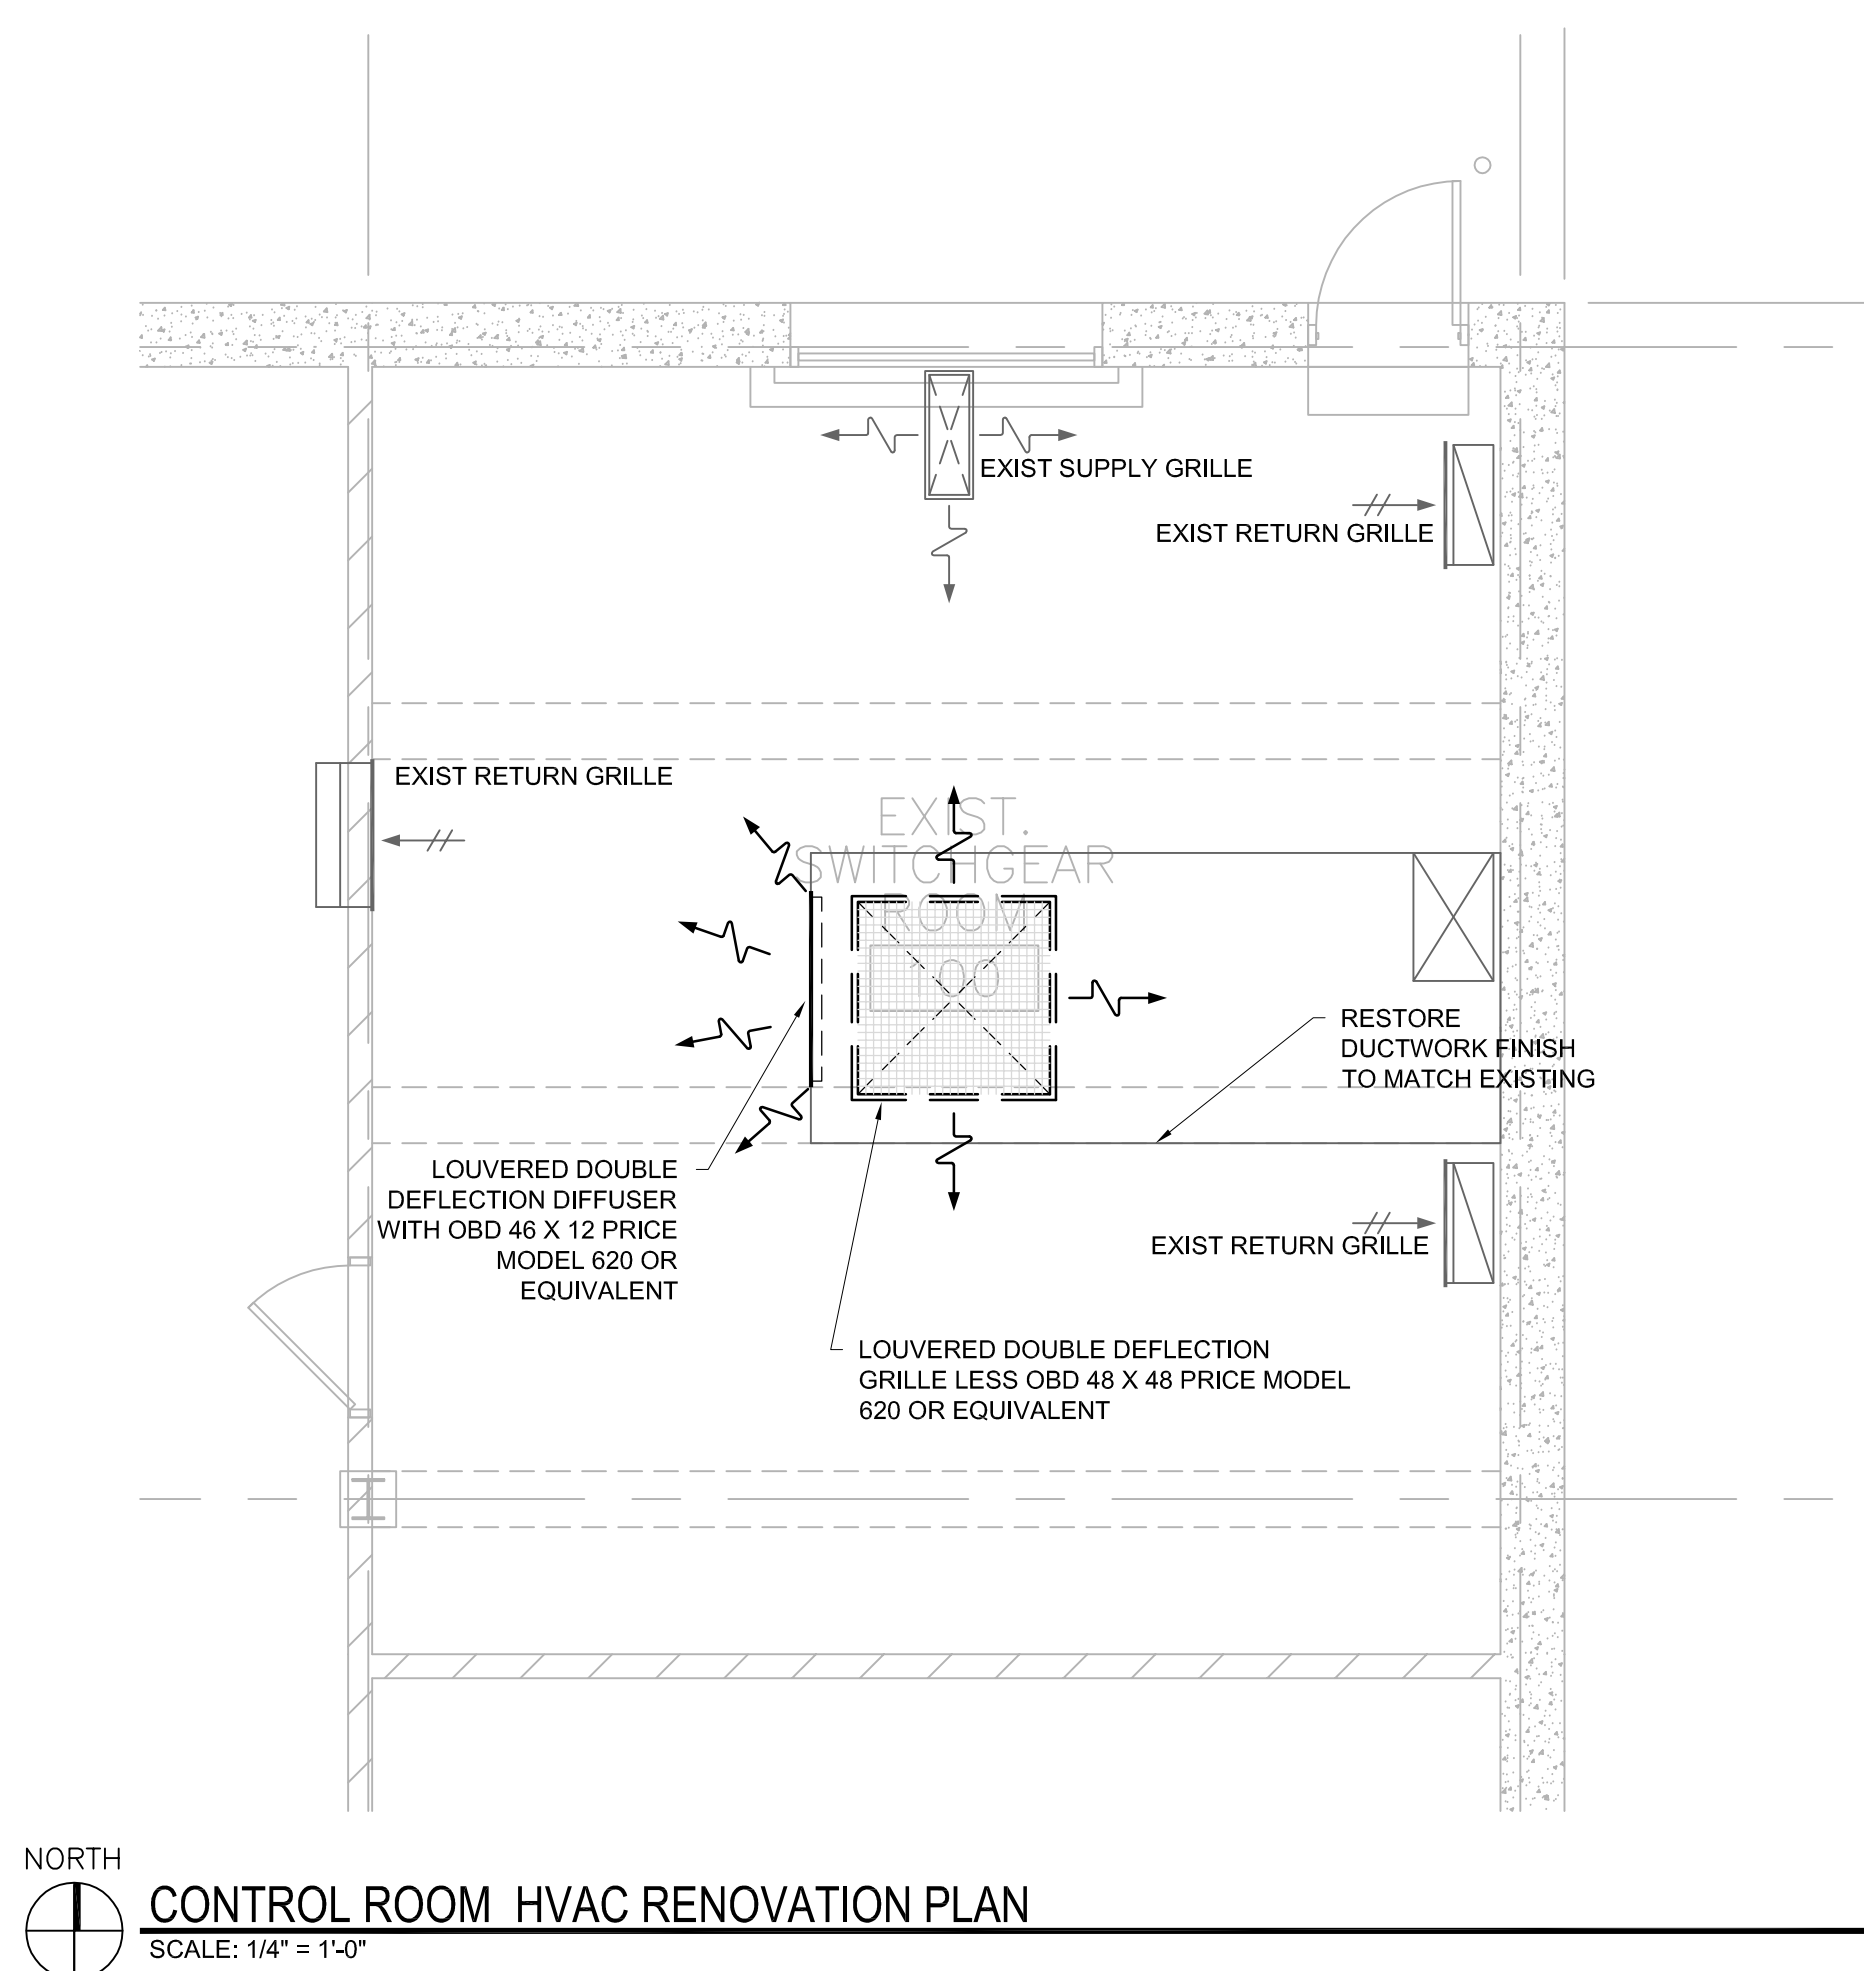

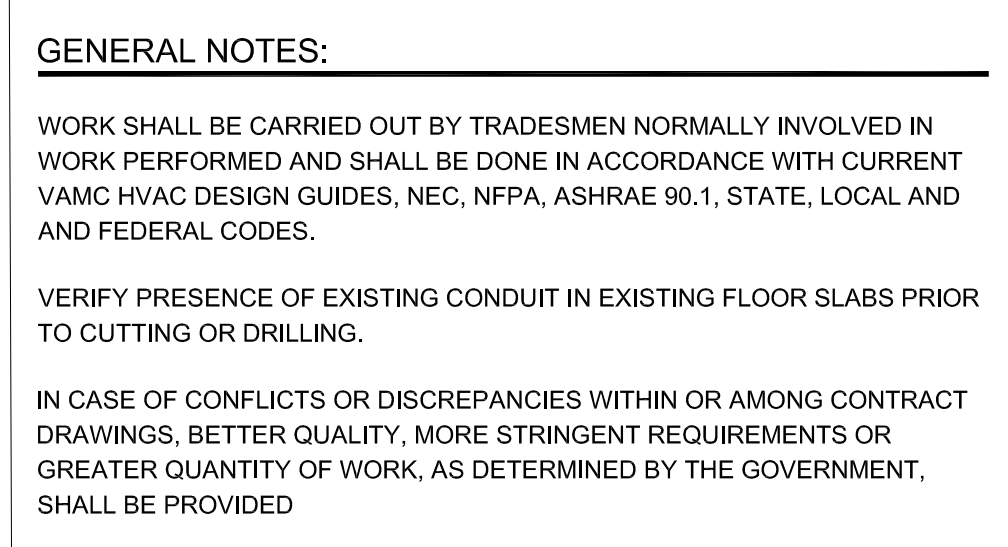


LEGEND

	SUPPLY DUCT UP/DOWN		SIDE ELBOW
	RETURN DUCT UP/DOWN		ELBOW UP
	EXHAUST DUCT UP/DOWN		ELBOW DOWN
	THERMOSTAT		SIDE TEE
	MOTORIZED DAMPER		TEE UP
	FIRE DAMPER		TEE DOWN
	POINT OF CONNECTION		STEAM TRAP
	POINT OF DISCONNECTION		WYE STRAINER
	EQUIPMENT / MATERIAL DESIGNATION		GATE VALVE
	DRAIN PIPING		GLOBE VALVE
	LOW PRESSURE STEAM SUPPLY		BALL VALVE
	LOW PRESSURE CONDENSATE RETURN		SWING CHECK VALVE
	STORM DRAIN PIPING		TWO POSITION CONTROL VALVE
	PLUMBING VENT PIPING		
	FUEL OIL RETURN		
	FUEL OIL SUPPLY		
	1 HOUR FIRE SEPARATION		

ABBREVIATIONS

MC	MECHANICAL CONTRACTOR
EG	ELECTRICAL CONTRACTOR
GC	GENERAL CONTRACTOR
TFB	TO FLOOR BELOW
APF	ABOVE FINISHED FLOOR
FFB	FROM FLOOR BELOW
FFA	FROM FLOOR ABOVE
FA	FRESH AIR
MFG.	MANUFACTURER/MANUFACTURED
CFM	CUBIC FT PER MINUTE

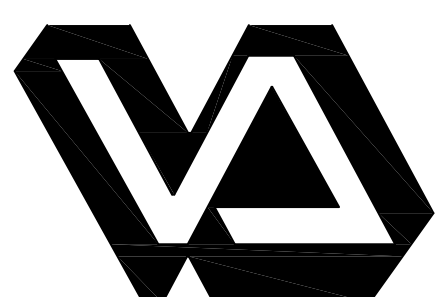[illegible]

Dept. of Veterans Affairs
Medical Center
5000 W. National Avenue
Milwaukee, WI




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Drawing Title	HVAC PLAN & DETAILS
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VERIFY SCALES

BAR BELOW IS 1" ON
ORIGINAL DRAWING

IF NOT 1" ON
REPRODUCTION, ADJUST
SCALES ACCORDINGLY

Project Title	Building 113 - Replace FCA Switchboard
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Location	VA Medical Center, Milwaukee, WI
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Date
20 July 2012

Checked By:

Drawn By:
JDG

CONSTRUCTION DOCUMENTS

Project Number	695-12-119
Building Number	113

Drawing Number

MH100

Office of
Facilities
Management



IN CASE OF CONFLICTS OR DISCREPANCIES WITHIN OR AMONG CONTRACT DRAWINGS, BETTER QUALITY, MORE STRINGENT REQUIREMENTS OR GREATER QUANTITY OF WORK, AS DETERMINED BY GOVERNMENT, SHALL BE PROVIDED.

ABBREVIATIONS:

ABV	ABOVE
AFF	ABOVE FINISHED FLOOR
AFS	ABOVE FINISHED GRADE
AIC	AVAILABLE INTERRUPTING CURRENT
A/E	ARCHITECT/ENGINEER
ALT	ALTERNATE
ALT SW	ALTERNATOR SWITCH
ARCH	ARCHITECT
ATS	AUTOMATIC TRANSFER SWITCH
BFG	BELOW FINAL GRADE
BLDG	BUILDING
BPC	BOLTED PRESSURE CONTACT SWITCH
BKR	BREAKER
BOL	BUILT IN OVERLOAD
CATV	CABLE TELEVISION
CCTV	CLOSED CIRCUIT TELEVISION
CB	CIRCUIT BREAKER
CKT	CIRCUIT
CLD	CEILING
CP	CONTROL PANEL
CS	COMBINATION STARTER
CT	CURRENT TRANSFORMER
DE	DUAL ELEMENT FUSES
DIR	DIRECT
DISC	DISCONNECT
DN	DOWN
EXIST	EXISTING
EC	ELECTRICAL CONTRACTOR
ELEV	ELEVATION REFERENCE
EM	EMERGENCY
ENT	ELECTRICAL NON-METALLIC TUBING
ENT	ELECTRIC METALLIC TUBING
EOL	END OF LINE RESISTOR
EP	EXPLOSION PROOF
ER	EXISTING TO BE REMOVED
ERL	EXISTING TO BE RELOCATED
ERLD	EXISTING RELOCATED
ETR	EXISTING TO REMAIN
EXIST	EXISTING
EW	ELECTRIC WATER COOLER
FLUSH	FLUSH
FAAP	FIRE ALARM ANNUNCIATOR PANEL
FACP	FIRE ALARM CONTROL PANEL
FBO	FURNISHED BY OTHERS
FDR	FEEDER
FIXT	FIXTURE
FLR	FLOOR
FLA	FULL LOAD AMPS
FLUOR	FLUORESCENT
FS	FLOW SWITCH
FVNR	FULL VOLTAGE NON-REVERSING
GC	GENERAL CONTRACTOR
GFI	GROUND FAULT INTERRUPTER
GRC	GALVANIZED RIGID CONDUIT
GRD	GROUND
CYP	CYPRESS BOARD
HID	HIGH INTENSITY DISCHARGE
HDA	HAND-OFF-AUTO SWITCH
HP	HORSEPOWER
HPS	HIGH PRESSURE SODIUM
HV	HIGH VOLTAGE
HVAC	HEATING & VENTILATING - AIR CONDITIONING
HVC	HEATING VENTILATING CONTRACTOR
HW	HEAVYWALL
ID	INDIRECT
IL	INTERLOCK
IMC	INTERMEDIATE METAL CONDUIT
INC	INCANDESCENT
IU	IN UNIT
J-BOX	JUNCTION BOX
LG	LAY-IN GRID
LTS	LIGHTING
LV	LOW VOLTAGE
LVT	LINE VOLTAGE THERMOSTAT
MAG	MAGNETIC STARTER
MAN	MANUAL STARTER
MCC	MOTOR CONTROL CENTER
MDP	MAIN DISTRIBUTION PANEL
MLO	MAIN LUGS ONLY
MSB	MAIN SWITCHBOARD
MID	MOUNTED
NC	NOT IN CONTRACT
NU	NEAR UNIT
OU	ON UNIT
P	POLE
PB	PUSHBUTTON
PEND	PENDANT
PC	PHOTO CONTROL
PE SW	PNEUMATIC SWITCH
PLB	PLUMBING CONTRACTOR
PNL	PANEL
RAI	RELAY
RE/CKT	RECONNECT TO EXISTING CIRCUIT
REC	RECESS
RECEPT	RECEPTACLE
RM	ROOM
RVS	REDUCED VOLTAGE STARTING
S	SPLINE
SEL SW	SELECTOR SWITCH
SP SW	SPEED SWITCH
SURF	SURFACE SW SWITCH
TC	TIME CLOCK
TC	TEMPERATURE CONTROL PANEL
TCC	TEMPERATURE CONTROL CONTRACTOR
T	TAMPER SWITCH
TYP	TYPICAL
UG	UNDERGROUND
UNIV	UNIVERSAL
USS	UNIT SUBSTATION
WP	WEATHERPROOF
XFMR	TRANSFORMER

SYSTEMS:

- 52 SMOKE DETECTOR (PHOTO-ELECTRIC TYPE)
- 15 FIRE ALARM AUDIO/VISUAL SIGNALING DEVICE - MOUNT 6' BELOW CEILING OR AT 8'-6" AFF, WHICHEVER IS LOWER.
- INDICATES CANDELA INTENSITY VALUE
- 1 FIRE ALARM MANUAL PULLSTATION - MOUNTED AT 44" AFF

GENERAL:

- ELECTRICAL PANEL - SEE SCHEDULE
- INDICATES DESIGNATION
- DRAWING NOTE SYMBOL
- (INDICATES DETAIL DESIGNATION)
- SEE DETAIL SYMBOL
- (INDICATES SHEET NUMBER)
- CONDUCTOR QUANTITY IN A RACEWAY, NUMBERS INDICATE WIRE SIZES (AWG).
- INDICATES PHASE CONDUCTOR
- INDICATES NEUTRAL CONDUCTOR
- INDICATES GREEN GROUND CONDUCTOR
- MOUNTING HEIGHT TO CENTER LINE OF UNIT
- FEEDER IDENTIFICATION

SYMBOLS LIST:

MOUNTING HEIGHTS FOR DEVICES AND EQUIPMENT TO BE MEASURED FROM FINISHED FLOOR TO CENTERLINE OF DEVICE.

LIGHTING:

- CEILING MOUNTED FLUORESCENT FIXTURE
- FIXTURE DESIGNATION (SEE SCHEDULE)
- CIRCUIT SWITCH LEG. NO DESIGNATION INDICATES PORTION OF CIRCUIT SWITCHED FROM LOCAL SWITCH OR OCCUPANCY SENSOR.
- SWITCHING DEVICE. NO DESIGNATION INDICATES PORTION OF CIRCUIT SWITCHED FROM LOCAL SWITCH OR OCCUPANCY SENSOR.
- (R) CIRCUIT SWITCHED VIA RELAY IN RELAY CABINET
- CIRCUIT NUMBER. SEE PLANS FOR PANEL BOUNDARIES.

- EMERGENCY BATTERY POWER SPOT ILLUMINATION UNIT - DUAL HEAD LIGHT - WALL MOUNT 12" BELOW CEILING UNLESS NOTED OTHERWISE.
- SINGLE POLE SWITCH - TOGGLE TYPE - MOUNT AT 44" AFF, UNLESS NOTED OTHERWISE

- SWITCH DESIGNATION
- (3) 3 WAY
- WITH PILOT LIGHT INDICATION

POWER:

- DUPLEX RECEPTACLE - MOUNTED 18" AFF UNLESS NOTED OTHERWISE
- CIRCUIT NUMBER (SEE PLAN FOR PANEL BOUNDARIES) - TYPICAL RECEPTACLE TYPE OR EQUIPMENT SERVED.
- (GFCI) GROUND FAULT CIRCUIT INTERRUPTER
- (WFP) WEATHERPROOF WITH GFI RECEPTACLE
- SPECIAL OUTLET - SEE SPECIAL OUTLET SCHEDULE
- MOTOR CONNECTION - SEE MOTOR WIRING SCHEDULE
- DISCONNECT SWITCH
- TRANSFORMER
- JUNCTION BOX
- METER SOCKET

BUILDING AUTOMATION WORK:

JOHNSON CONTROL INCORPORATED (HEREIN REFERENCED AS JCI), AS AN APPROVED SOLE SOURCE PROVIDER OF BUILDING AUTOMATION AND HVAC CONTROL EQUIPMENT AND SERVICES, SHALL PROVIDE THE NECESSARY EQUIPMENT, INSTALLATION, WIRING, PROGRAMMING AND TESTING TO ACCOMPLISH THE TIE IN OF THE FOLLOWING ALARMS THROUGH THE BUILDING 111 METASTYS BUILDING AUTOMATION SYSTEM.

- TRANSFORMER HIGH TEMPERATURE ALARM THROUGH A BINARY CONTACT LOCATED IN THE TRANSFORMER ALARM CABINET ON EACH TRANSFORMER.
 - TRANSFORMER HIGH PRESSURE ALARM CONTACT THROUGH A BINARY CONTACT LOCATED IN THE TRANSFORMER ALARM CABINET ON EACH TRANSFORMER.
 - TRANSFORMER LOW LIQUID LEVEL ALARM CONTACT THROUGH A BINARY CONTACT LOCATED IN THE TRANSFORMER ALARM CABINET ON EACH TRANSFORMER.
- PROVIDE ALARM WIRING FROM EACH AUXILIARY CONTACT ARE BROUGHT OUT TO A TERMINATION STRIP LOCATED IN AN ALARM TERMINAL CABINET ON THE FRONT OF EACH TRANSFORMER.
- THE COST ALL EQUIPMENT AND SERVICES BY JCI SHALL BE INCLUDED AS PART OF THE BASE BID.

REFERENCED NOTES:

- ASSUMED ROUTE OF EXISTING 13.2 PRIMARY UNDERGROUND FEEDER TO EACH TRANSFORMER. ASSUME THE EXISTING RACEWAY IS 4" LD. VERIFY AT SITE.
- CUT AND PATCH EXISTING FLOOR TO FACILITATE NEW CONDUIT SECTION. THE CONTRACTOR SHALL PULL BACK THE EXISTING FEEDER AT THE EXISTING MANHOLE EAST OF BUILDING 113 TO ALLOW MODIFICATION TO THE PRIMARY FEEDER CONDUIT.
- LOCATION OF EXISTING CONDUIT STUB INTO EXISTING TRANSFORMER.
- INTERCEPT EXISTING FEEDER CONDUIT AND EXTEND NEW FEEDER CONDUIT SECTION IN FLOOR INTO THE NEW TRANSFORMER AIR TERMINAL CHAMBER. RACEWAY SHALL BE EITHER GALVANIZED RIGID STEEL CONDUIT OR SCHEDULE 40 PVC CONDUIT.
- LOCATION OF NEW AIR TERMINAL CABINET ON TRANSFORMER.
- NEW 4" CONDUIT SECTION, STUB-UP INTO AIR TERMINAL CABINET OF TRANSFORMER. PULL EXISTING FEEDER BACK THROUGH THE NEW FEEDER EXTENSION. A NEW TRANSFORMER FEEDER WAS INSTALLED IN THE BUILDING 115 PRIMARY SWITCHGEAR REPLACEMENT PROJECT. THIS FEEDER WAS PROVIDED WITH ADDITIONAL LENGTH EITHER VIA LOOPING THE MANHOLE OR PROVIDING A LOOP IN THE NEW CABLE VAULT OF NEW BUILDING 115 TO ACCOMMODATE THIS CONDUIT EXTENSION.
- 2-4" EMPTY CONDUITS PROVIDED UNDER THE BUILDING 115 PRIMARY SWITCHGEAR REPLACEMENT PROJECT. ONE 4" CONDUIT MAY BE USED FOR ROUTING OF HIGH PRESSURE ALARM TRIP OF FEEDER FOR EACH TRANSFORMER FROM RELATED SWITCHGEAR BAY IN BUILDING 115. WIRE ONTO TERMINALS PROVIDED IN FRONT OF CIRCUIT BREAKER - COORDINATE WITH BLDG 115 PROJECT CONTRACTOR.
- ALARM TERMINAL STRIP IN CABINET ON FRONT OF EACH TRANSFORMER.
- PROVIDE A SINGLE 6 CONDUCTOR #14 MC CABLE AND PULL THROUGH THE EXISTING 4" CONDUIT. TRANSITION FROM CABLE IN CONDUIT TO TYPE MC CABLE AT A JUNCTION BOX NEAR THE SPARE CONDUIT STUBBED THROUGH THE WALL. TWO OF THE CONDUCTORS IN THE MC CABLE ARE SPARES. TERMINATE 2#14 EACH ON SWITCHGEAR CIRCUIT BREAKERS NW-3 AND SW-3 IN BUILDING 115. WIRE ONTO TERMINALS PROVIDED IN FRONT OF CIRCUIT BREAKER - COORDINATE WITH BLDG 115 PROJECT CONTRACTOR. THESE 16 KV FEEDER CIRCUIT BREAKERS ARE TO TRIP ON A HIGH PRESSURE ALARM REGISTERED AT THE TRANSFORMER.

SHEET INDEX:

E000	ELECTRICAL SYMBOLS & ABBREVIATIONS
E100	SWGR ROOM PLAN - ELECTRICAL
E101	CHILLER PLANT - ELECTRICAL
E102	ONE LINE POWER DISTRIBUTION DIAGRAM - SWITCHBOARD #1
E103	ONE LINE POWER DISTRIBUTION DIAGRAM - SWITCHBOARD #2
Y100	FLOOR PLAN - LOWER LEVEL - TECHNOLOGY

13.2 KV FEEDER MODIFICATIONS & ALARM WIRING - ROOM 100



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Drawing Title
Electrical Symbols & Abbreviations

VERIFY SCALES

BAR BELOW IS 1" ON ORIGINAL DRAWING
IF NOT 1" ON REPRODUCTION, ADJUST SCALES ACCORDINGLY

Project Title
Building 113 - Replace FCA Switchboard

Location
VA Medical Center, Milwaukee, WI

Date
20 JULY 2012

Checked By:
G+L

Drawn By:
G+L

CONSTRUCTION DOCUMENTS

Project Number
695-12-119


Building Number
113

Drawing Number
E000

Office of
Facilities
Management

Department of
Veterans Affairs

A
three inches = one foot
B
one and one half inches = one foot
C
one inch = one foot
D
three quarters inch = one foot
E
one half inch = one foot
F
three eighths inch = one foot
one quarter inch = one foot
one eighth inch = one foot

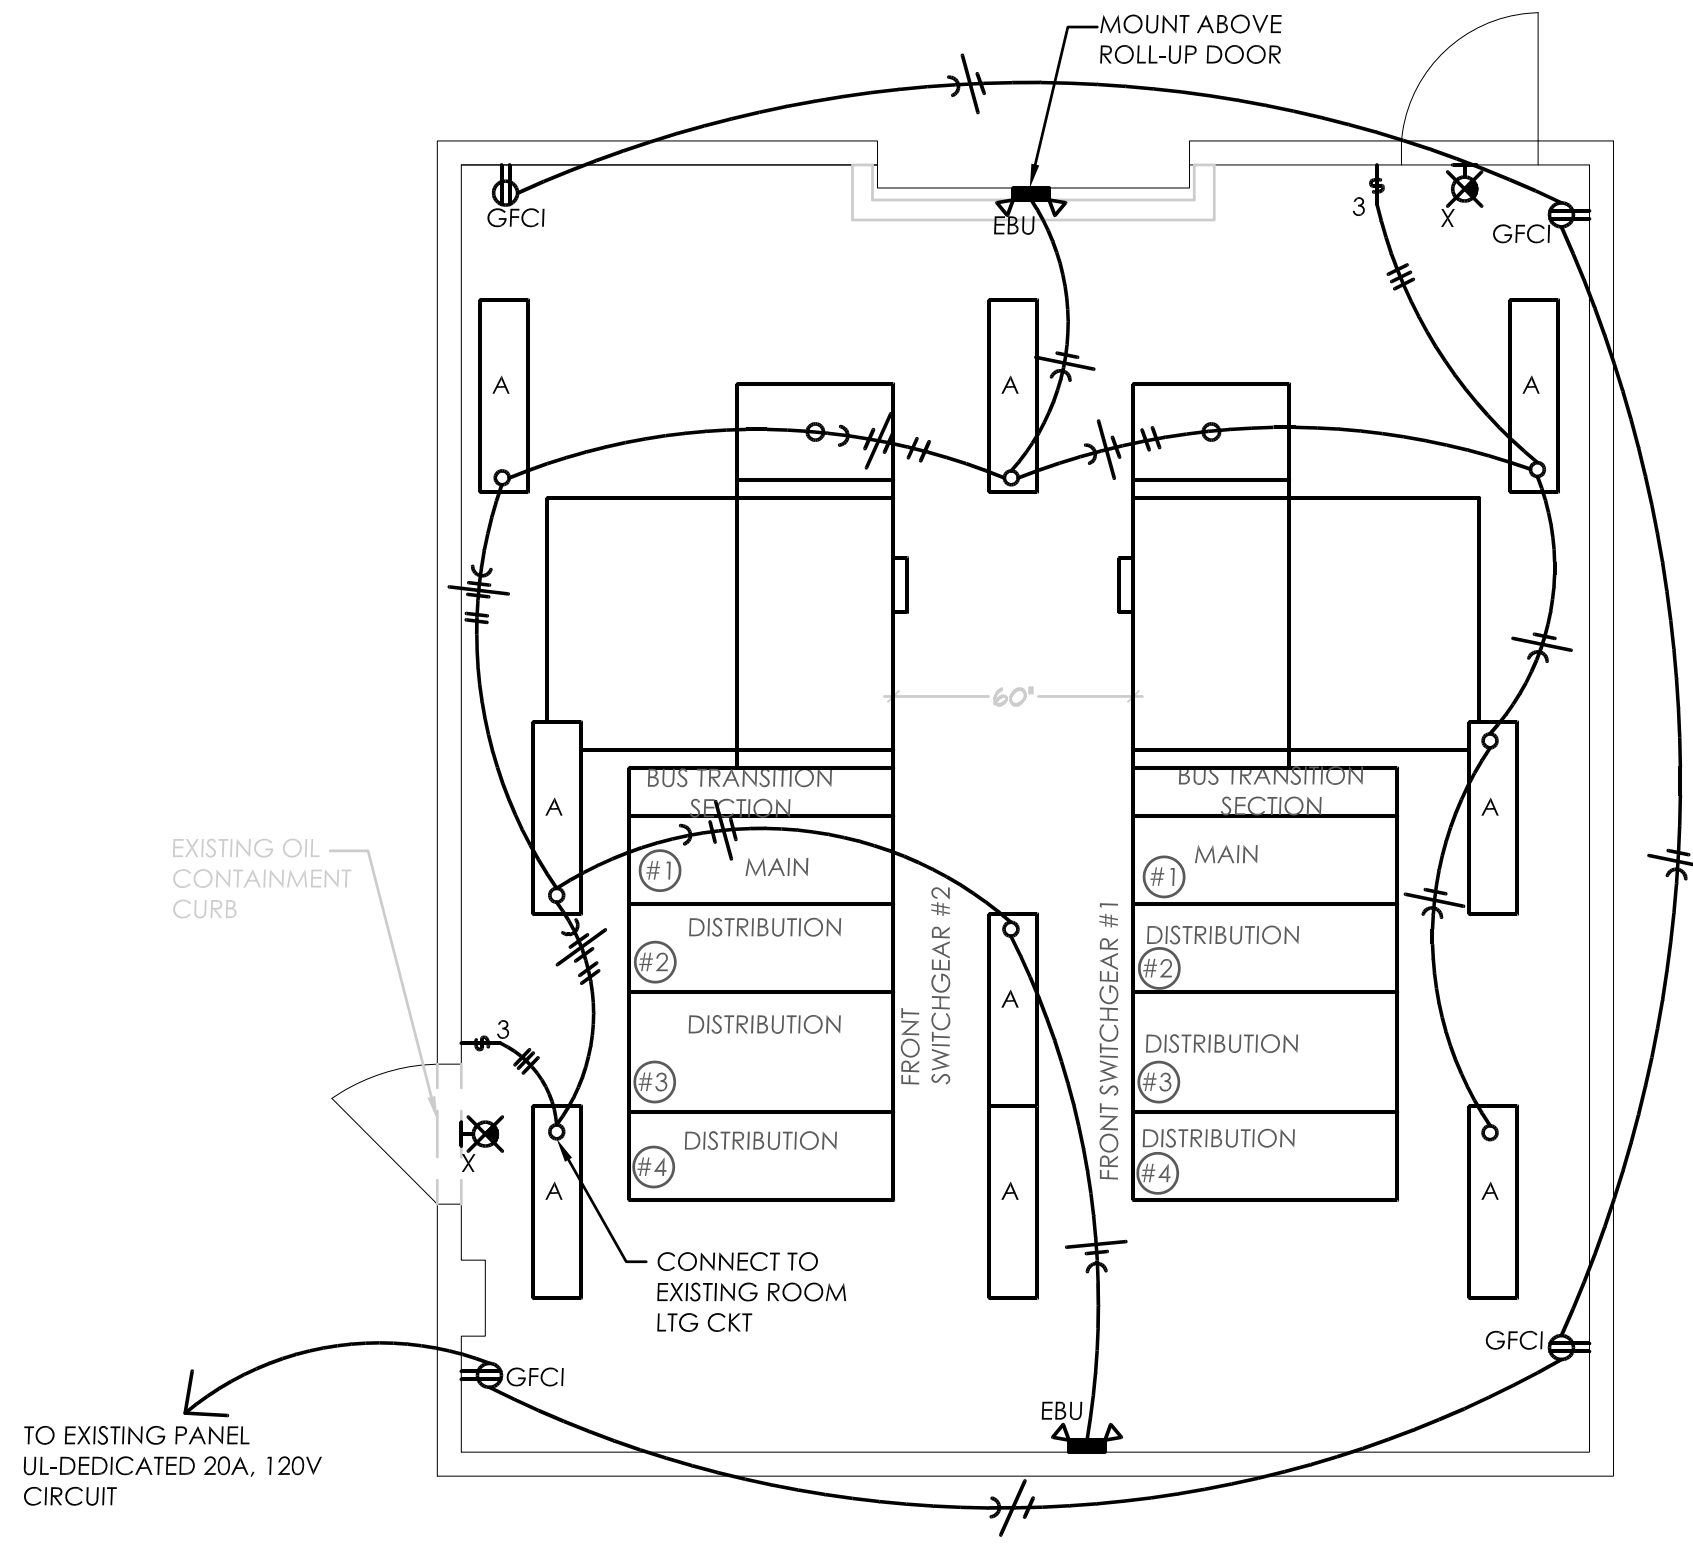


NOTE:
CAPTURE THE EXISTING EXIT LIGHTING CIRCUIT IN THIS ROOM AND EXTEND TO ALL NEW EXIT SIGNS

- FIXTURES:**
1. FIXTURE A - 2 LAMP, T-8 INDUSTRIAL FLUORESCENT WITH REFLECTOR AND LAMP GUARD. PROVIDE WITH HFC MULTI-TAP BALLAST - MOUNT WITH STEMS AND SWIVEL HANGERS.
 2. EBU - 2 LAMP EMERGENCY BATTERY UNIT WITH BUILT IN CHARGER AND TEST SWITCH - PROVIDE 2 LIGHTING HEADS AND 90 MIN BATTERY CAPACITY. WIRE TO UNSWITCHED LEG OF RM LIGHTING CIRCUIT. VERIFY INPUT VOLTAGE.
 3. X-LED STENCIL FACE EXIT SIGN WITH 6" HIGH RED LETTERS AND POLYCARBONATE BODY. FIXTURE SHALL ALLOW UNIVERSAL MOUNTING AND UNIVERSAL VOLTAGE MOUNT EXIT SIGNS 12" ABOVE DOOR FRAME.

FLOOR PLAN-LIGHTING RECEPTACLE 5
SCALE: 1/4" = 1'-0"

- SYMBOLS LIST:**
- GROUND
 - PENDANT MOUNTED FLUORESCENT FIXTURE
 - EMERGENCY BATTERY POWER SPOT ILLUMINATION UNIT - DUAL HEAD LIGHT - WALL MOUNT 12" BELOW CEILING UNLESS NOTED OTHERWISE.
 - SINGLE POLE SWITCH - TOGGLE TYPE - MOUNT AT 44" AFF, UNLESS NOTED OTHERWISE
 - JUNCTION BOX
 - DUPLEX RECEPTACLE - MOUNTED 18" AFF UNLESS NOTED OTHERWISE
 - GFCI = GROUND FAULT CIRCUIT INTERRUPTER
 - FIRE ALARM MANUAL PULLSTATION - MOUNTED AT 44" AFF
 - FIRE ALARM AUDIO/VISUAL SIGNALLING DEVICE - MOUNT 6" BELOW CEILING OR AT 6'-8" AFF, WHICHEVER IS LOWER. INDICATES CANDELA INTENSITY VALUE
 - SMOKE DETECTOR (PHOTO-ELECTRIC TYPE)
 - DRAWING NOTE SYMBOL
 - CONDUCTOR QUANTITY IN A RACEWAY. NUMBERS INDICATE WIRE SIZES (AWG).
 - INDICATES PHASE CONDUCTOR
 - INDICATES NEUTRAL CONDUCTOR
 - INDICATES GREEN GROUND CONDUCTOR

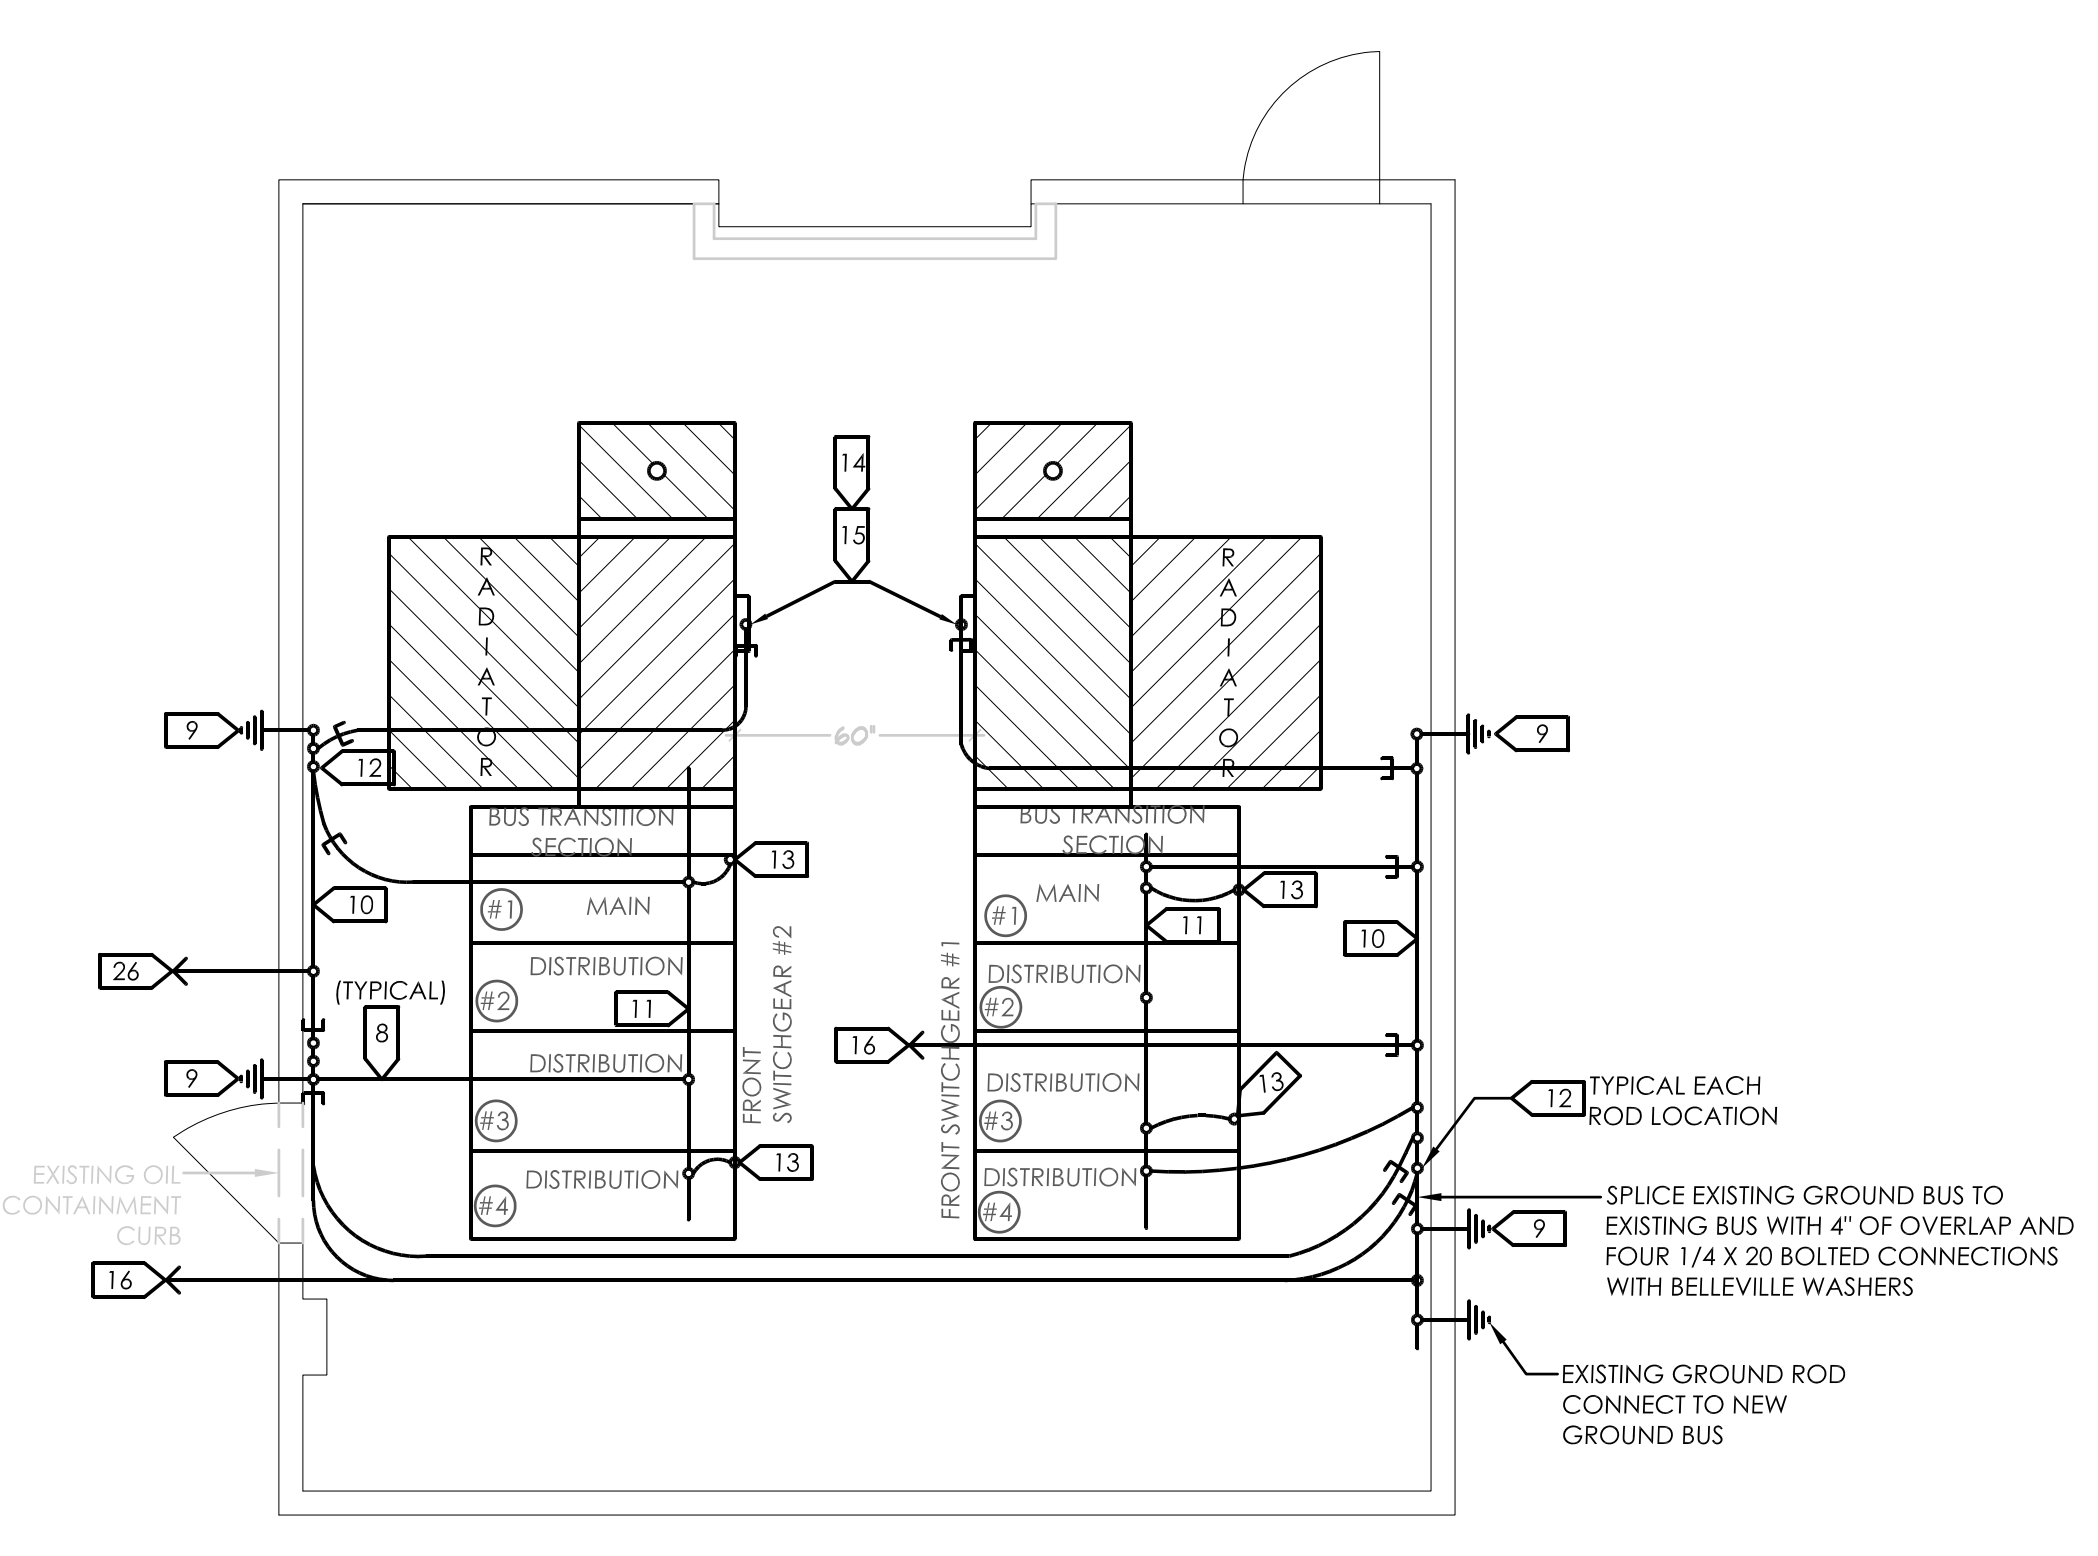


FLOOR PLAN-GROUNDING PLAN 3
SCALE: 1/4" = 1'-0"

- PHASING NOTES:**
1. REMOVAL OF EXISTING SWITCHBOARDS AND INSTALLATION OF NEW SWITCHGEAR SHALL BE PERFORMED BETWEEN NOV. 15TH 2013 AND APRIL 1ST 2014.
 2. 2ND SWITCHBOARD REMOVAL SHALL NOT OCCUR UNTIL 1ST SWITCHGEAR LINE IS INSTALLED, TESTED AND ENERGIZED.


- LAYOUT NOTES:**
1. NEW SWITCHGEAR SECTION LAYOUT SHALL LINE UP SO CENTERLINES OF NEW AND EXISTING DISTRIBUTION SECTIONS ALLOW CAPTURE OF EXISTING FEEDER CONDUITS IN FLOOR.

- GENERAL NOTES:**
1. MINIMUM SIZE GROUNDING CONDUCTOR INDICATED ON GROUNDING PLAN SHALL BE #3/0 BARE COPPER. ROUTE IN SCHEDULE 40 PVC CONDUIT EXCEPT INSIDE OF EQUIPMENT ENCLOSURES.
 2. SEE DWG E101 FOR LOCATION OF GROUNDING BOND TO CHILLED WATER PIPING.
 3. PROVIDE GROUNDING BUSHING ON ALL METALLIC CONDUITS ENTERING NEW SWITCHBOARDS. TIE BUSHING TOGETHER AND ONTO CONTINUOUS GROUND BUS INSIDE SWITCHGEAR.
 4. SIZE JUNCTION BOXES PER ARTICLE 314 OF NATIONAL ELECTRICAL CODE.

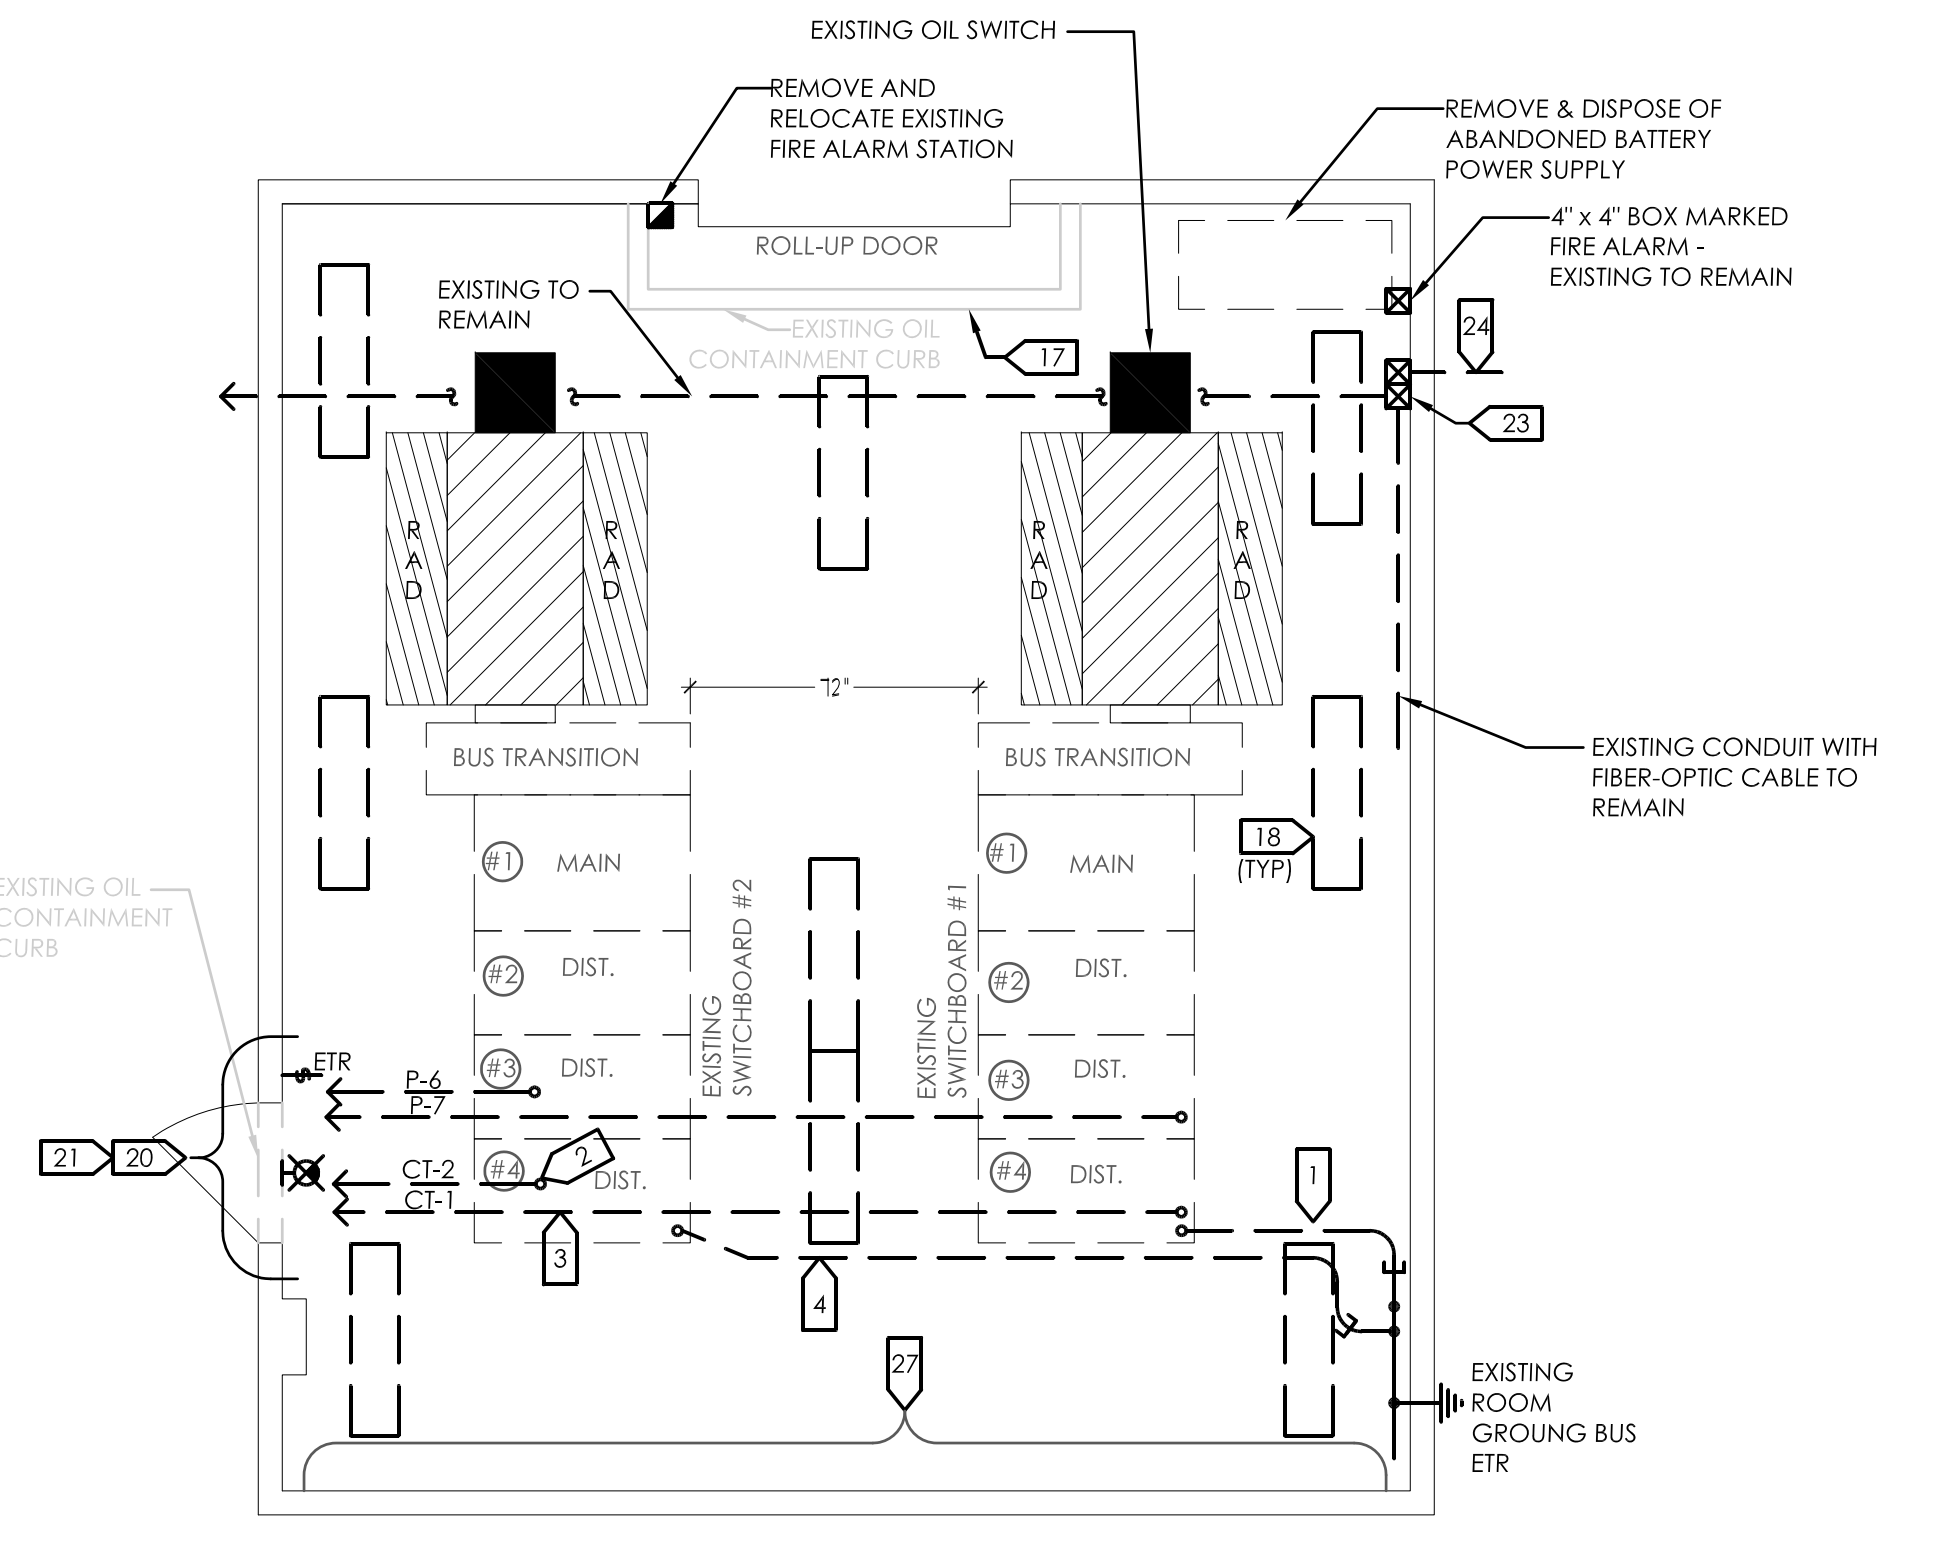



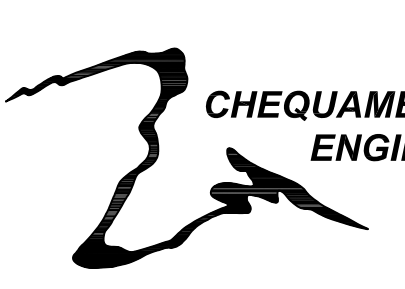
- REFERENCED NOTES:**
1. REMOVE EXISTING OVERHEAD CONDUIT WITH ELECTRODE GROUNDING CONDUCTOR - TO EXISTING SWITCHBOARDS #1 AND #2.
 2. REMOVE EXISTING 200A OVERHEAD FEEDER TO CT FAN-2. RE-FEED FROM NEW MDP-1.
 3. REMOVE EXISTING 200A OVERHEAD FEEDER TO CT FAN-1. RE-FEED FROM NEW MDP-2.
 4. REMOVE EXISTING GROUNDING CONDUCTOR & CONDUIT.
 5. NEW 800A FEEDER ROUTED OVERHEAD TO NEW MDP-1.
 6. NEW 800A FEEDER ROUTED OVERHEAD TO NEW MDP-2.
 7. NOT USED
 8. #3/0 GREEN THHN CU IN SCHEDULE 40 PVC CONDUIT - CONNECTION BETWEEN ROOM GROUND BUS AND GROUND BUS IN SWITCHGEAR.
 9. 5/8" X 20'-0" SECTIONAL GROUND ROD CORE FLOOR AND DRIVE ROD THROUGH CORE. FILL IN CORE WITH PATCHING CONCRETE UPON COMPLETION OF GROUND ROD INSTALLATION. X-RAY FLOOR SLAB TO AVOID DRIVING ROD THROUGH ANY EXISTING UNDERGROUND FEEDERS OR OTHER PIPING. PROVIDE UP TO 3 X-RAYS AT EACH GROUND ROD LOCATION.
 10. 1/4" X 4" COPPER GROUND BUS. FASTEN TO WALL WITH INSULATED STAND-OFFS (MOUNT @ 12" AFF)
 11. CONTINUOUS COPPER GROUND BUS IN SWITCHGEAR.
 12. CONNECT TO GROUND BUS WITH NON-REMOVABLE ONE-WAY HIGH COMPRESSION FITTING.
 13. GROUND SWITCHGEAR FRAME TO THE CONTINUOUS GROUND BUS AT EACH END OF THE SWITCHGEAR. PROVIDE ADDITIONAL CONNECTIONS AT SHIPPING SPLITS.
 14. TIE TO GROUND PAD ON EXISTING TRANSFORMER - CONNECT WITH TWO HOLE LONG BARREL HIGH COMPRESSION CRIMP LUGS.
 15. LOCATION OF GROUNDING PAD ON TRANSFORMER.
 16. BOND TO BUILDING 113 WATER SERVICE INSIDE CHILLED WATER PLANT WITH #3/0 THHW COPPER IN CONDUIT - SEE DRAWING E101 FOR LOCATION.
 17. EXISTING OIL CONTAINMENT CURB SHALL BE MODIFIED AS INDICATED UNDER BASE BID FLOOR PLAN - SEE THE ARCHITECTURAL DRAWINGS FOR DETAILS.
 18. REMOVE & DISPOSE OF EXISTING LIGHTING FIXTURES.
 19. SUB-UP LOCATION FOR EXISTING PRIMARY FEEDER CONDUIT THROUGH FLOOR - (CAPTURE AND RE-TERMINATE)
 20. EXISTING FEEDERS TO P-6 AND P-7. CONTINUED ON DWG E-101. PROVIDE NEW FEEDER SECTION BETWEEN SWITCHGEAR AND EXISTING JUNCTION.
 21. EXISTING OVERHEAD FEEDERS TO CT-1 AND CT-2 REFEED FROM NEW MDP-1 AND MDP-2. SEE DWG E101. REMOVE ENTIRE LENGTH OF EXISTING FEEDER.
 22. NOT USED
 23. EXISTING JUNCTION BOXES CONTAINING FIBER-OPTIC CABLE - EXISTING TO REMAIN.
 24. EXISTING FIBER-OPTIC CABLE - PROTECT DURING CONSTRUCTION.
 25. EXISTING PORTABLE GENERATOR CONNECTION RECEPTACLE TO REMAIN - PROTECT DURING CONSTRUCTION.
 26. #3/0 THHW COPPER IN CONDUIT - BOND TO COLUMN INDICATED ON DWG E101.
 27. EXISTING EQUIPMENT ON THIS WALL SHALL REMAIN.




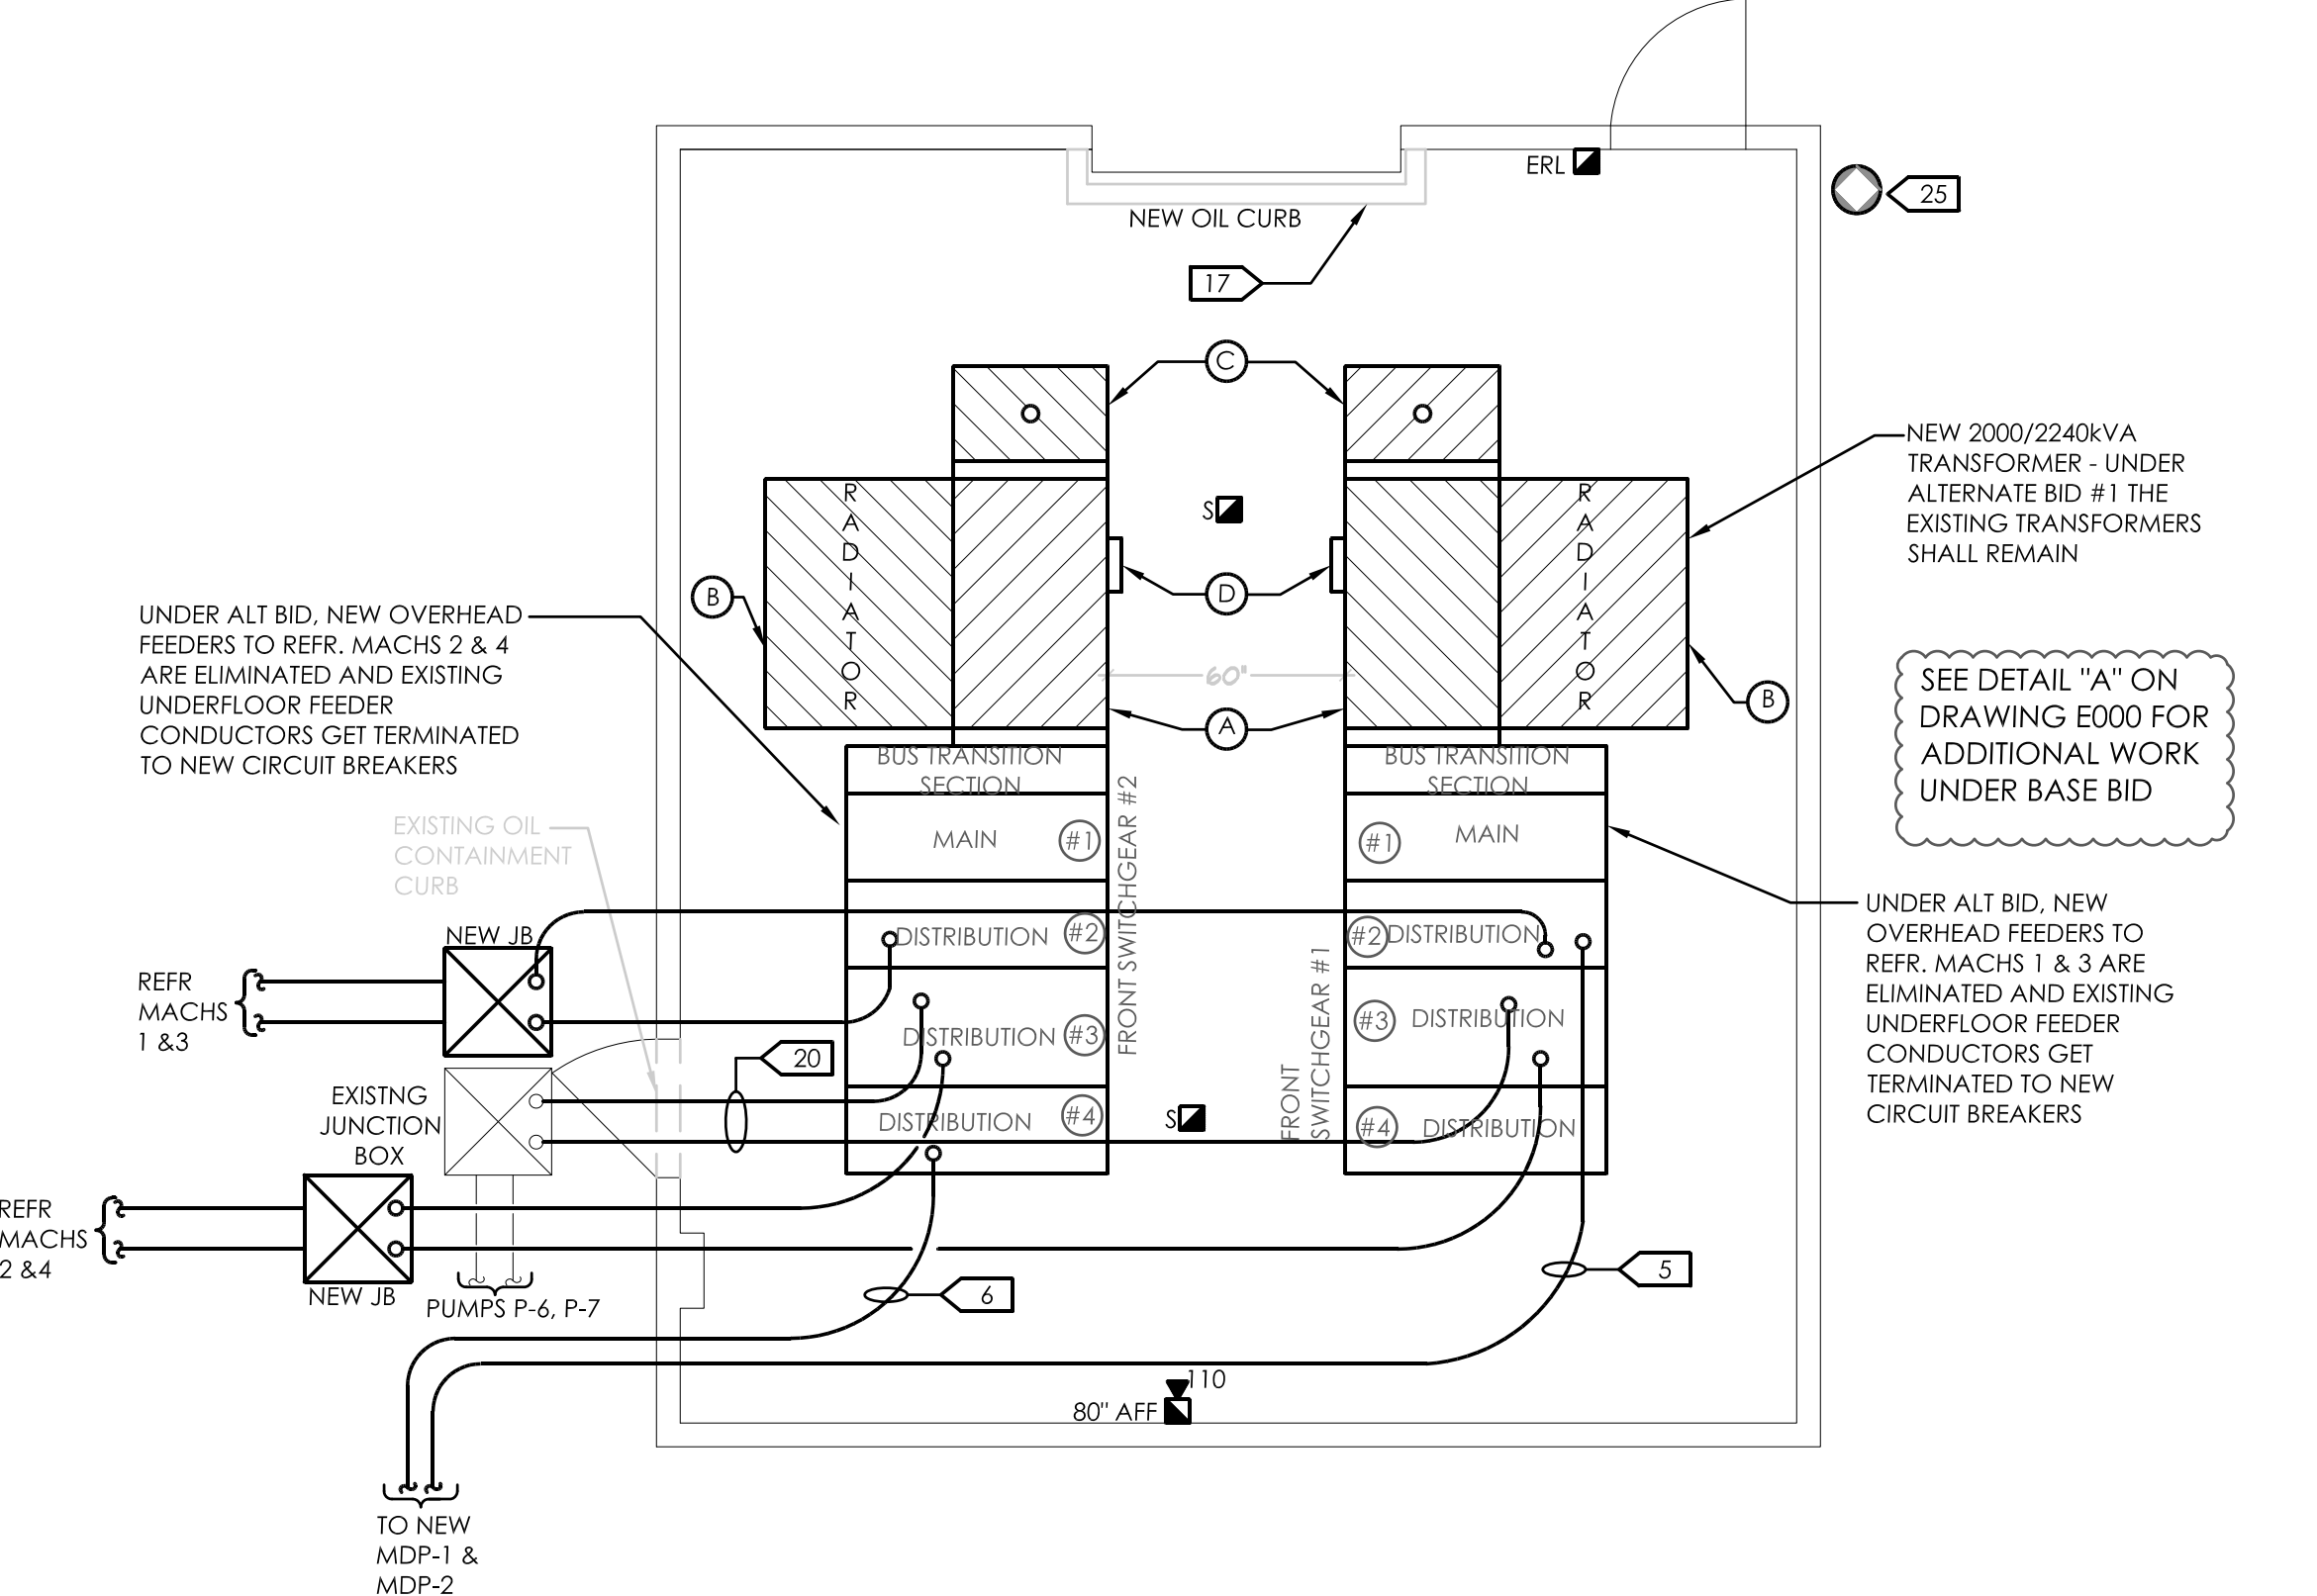


FLOOR PLAN-DEMOLITION 1
SCALE: 1/4" = 1'-0"

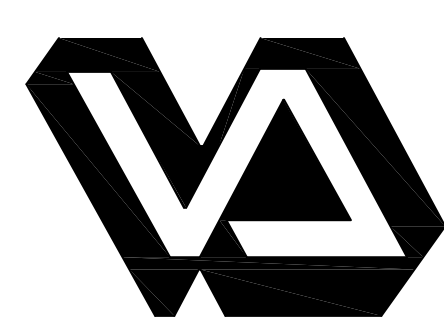

BASE BID - FLOOR PLAN 2
SCALE: 1/4" = 1'-0"



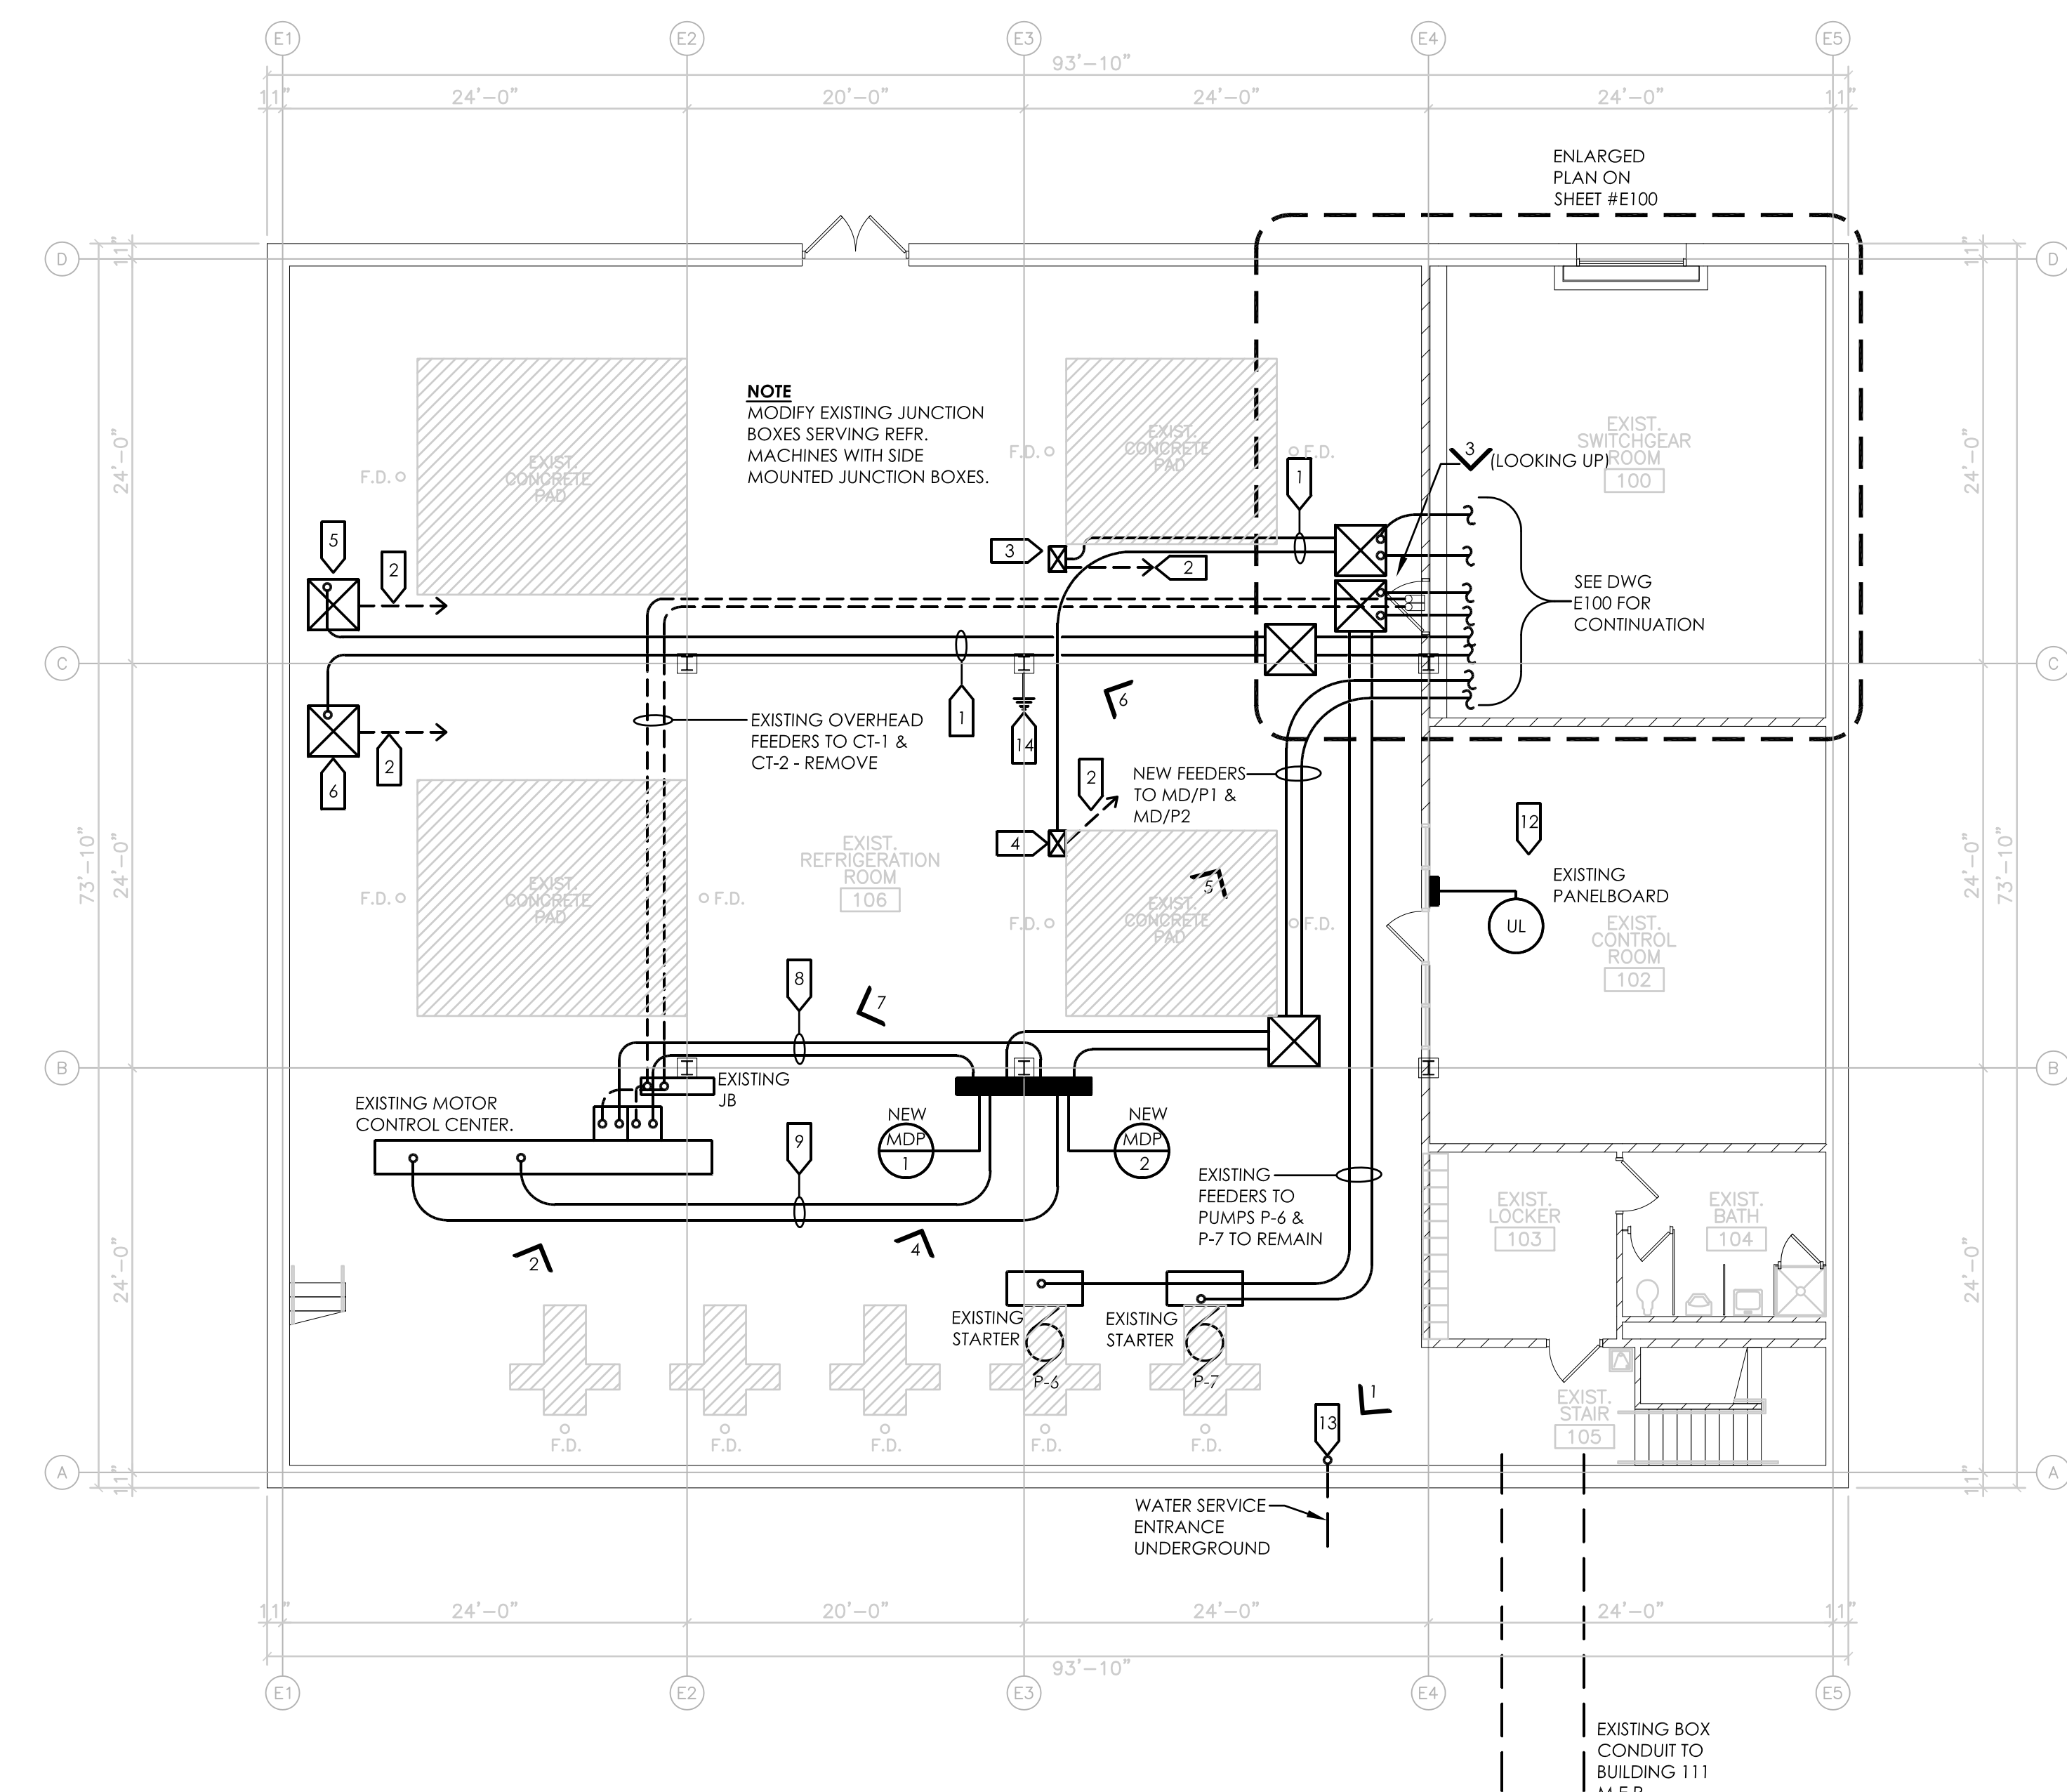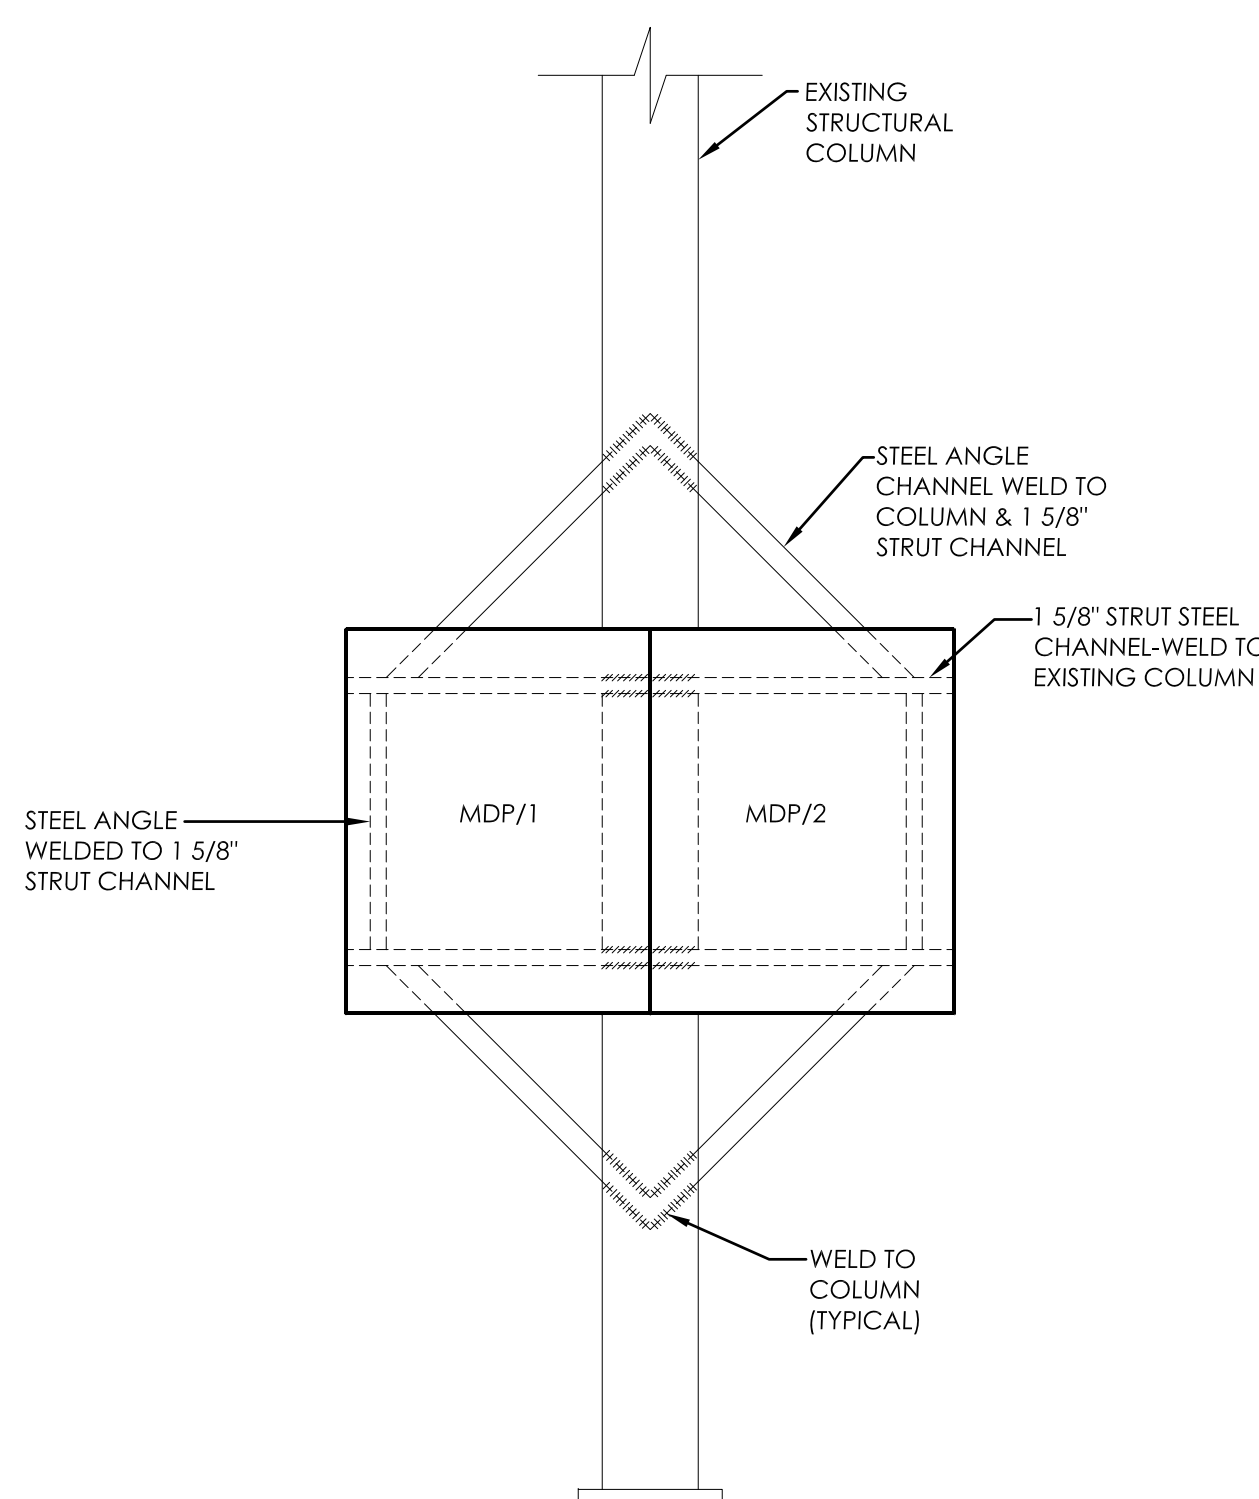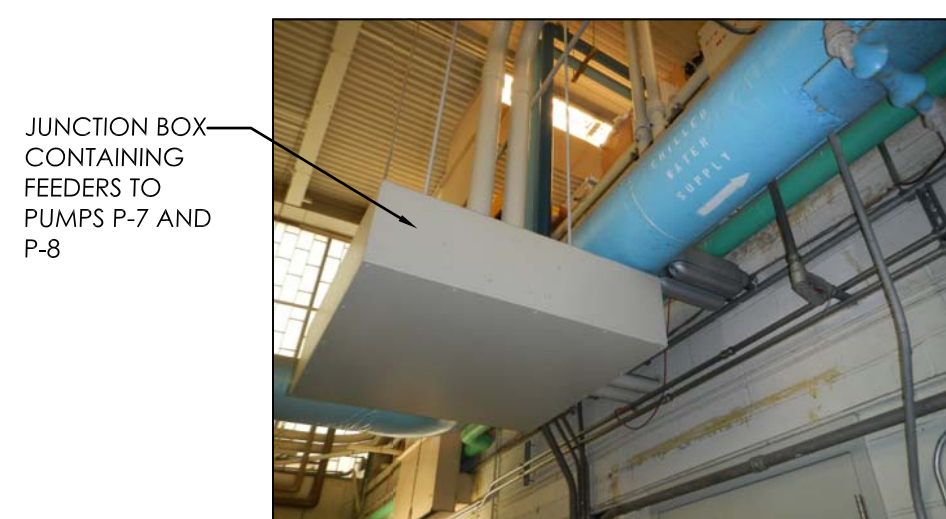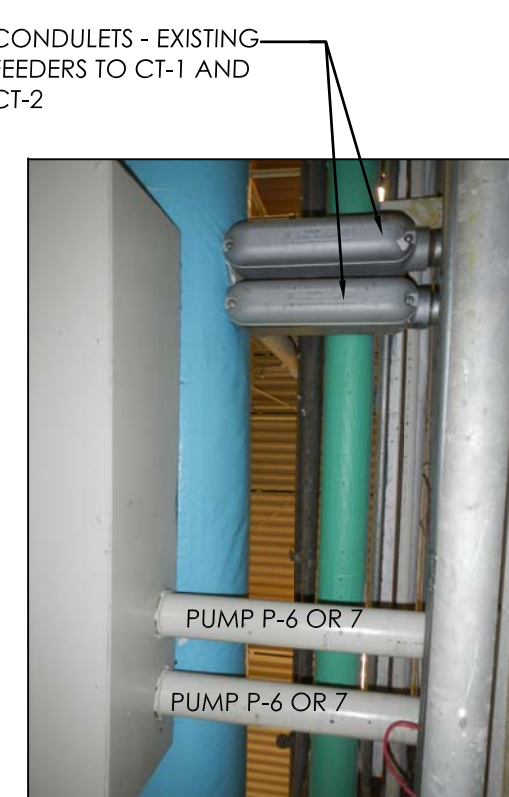


 Dept. of Veterans Affairs Medical Center 5000 W. National Avenue Milwaukee, WI			CONSULTANTS:  THE SIGMA GROUP Single Source. Sound Solutions. www.thesigmagroup.com 1300 West Canal Street Milwaukee, WI 53233 Phone: 414-643-4200 Fax: 414-643-4210	 GL GEIGER+LARSON ENGINEERING GEIGER+LARSON ENGINEERING INC 316 N Milwaukee St Suite 202 Milwaukee, WI 53202 T: 414-273-1432 www.GeigerEng.com	PROJECT LEADER/STRUCTURAL ENGINEER:  CHEQUAMEGON BAY ENGINEERING, INC. 1100 N. MAYFAIR RD., SUITE 208 MILWAUKEE, WI 53226 PHONE: (414) 258-8004 FAX: (414) 258-8154	Drawing Title Swgr Room Plan - Electrical	Project Title Building 113 - Replace FCA Switchboard	Project Number 695-12-119	Building Number 113	Office of Facilities Management	
Revisions:						VERIFY SCALES BAR BELOW IS 1" ON ORIGINAL DRAWING IF NOT 1" ON REPRODUCTION, ADJUST SCALES ACCORDINGLY	Location VA Medical Center, Milwaukee, WI	Drawing Number E100	Checked By: G+L	Drawn By: G+L	Department of Veterans Affairs
Date 20 JULY 2012							Date 20 JULY 2012				



- REFERENCED NOTES:**

1. PROVIDE NEW OVERHEAD FEEDER, SEE ALTERNATE BID #2 ROUTE HIGH, NEAR UNDERSIDE OF ROOF DECK.
2. EXISTING FEEDER ROUTED THROUGH FLOOR SLAB - REMOVE CONDUCTOR. SEE ALTERNATE #2.
3. EXISTING 1/2" x 18" x 72" H VERTICALLY MOUNTED JUNCTION BOX MOUNTED ON FLOOR SERVING REFR. MACH #1 - SPLICE NEW OVERHEAD FEEDER TO EXISTING FEEDER SECTION SERVING STARTER INSIDE EXISTING JUNCTION BOX.
4. EXISTING 1/2" x 18" x 72" H VERTICALLY MOUNTED JUNCTION BOX MOUNTED ON FLOOR SERVING REFR. MACH #2 - SPLICE NEW OVERHEAD FEEDER TO EXISTING FEEDER SECTION SERVING STARTER INSIDE EXISTING JUNCTION BOX.
5. EXISTING 24" x 24" x 72" H VERTICALLY MOUNTED JUNCTION BOX MOUNTED ON FLOOR SERVING REFR. MACH #4 - SPLICE NEW OVERHEAD FEEDER TO EXISTING FEEDER SECTION SERVING STARTER INSIDE EXISTING JUNCTION BOX.
6. EXISTING 1/2" x 18" x 72" H VERTICALLY MOUNTED JUNCTION BOX MOUNTED ON FLOOR SERVING REFR. MACH #3 - SPLICE NEW OVERHEAD FEEDER TO EXISTING FEEDER SECTION SERVING STARTER INSIDE EXISTING JUNCTION BOX.
7. NOT USED.
8. NEW FEEDERS TO CT-1 AND CT-2.
9. NEW FEEDERS TO MCC-C AND MCC-D.
10. NOT USED.
11. NOT USED.
12. EXISTING SQUARE D QOC LOAD CENTER SERVED VIA BUILDING 111 EMERGENCY POWER AND CONTAINING 4 QIP SPACES. ADD A NEW 20A, 1P CIRCUIT BREAKER IN ONE EXISTING SPACE.
13. GROUNDING ELECTRODE FOR GROUNDING OF ELECTRICAL SWITCHBOARDS.
14. PROVIDE 1/2SD BARE COPPER IN 1" SCHEDULE 40 WPC CONDUCTOR BETWEEN WEST WALL GROUND BUS IN RAUM AND THIS COLUMN. EXO-THERMICALLY WELD TO COLUMN AND AT WEST WALL GROUND BUS IN RM 100.

SYMBOLS LIST:

- | | |
|---|--|
|  | MOTOR CONNECTION - SEE MOTOR WIRING SCHEDULE |
|  | JUNCTION BOX |
|  | ELECTRICAL PANEL - SEE SCHEDULE |
|  | INDICATES DESIGNATION |
|  | DRAWING NOTE SYMBOL |

[illegible]


Dept. of Veterans Affairs
Medical Center
5000 W. National Avenue
Milwaukee, WI



CONSULTANTS:



PROJECT LEADER/STRUCTURAL ENGINEER:

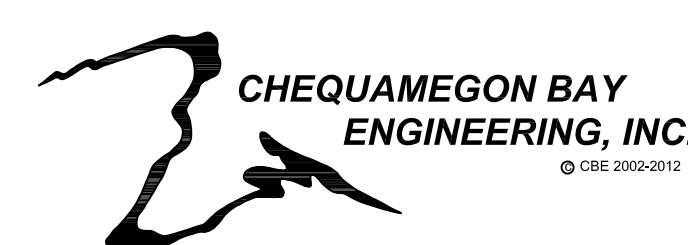

Drawing Title	Chiller Plant - Electrical
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Project Title	Building 113 - Replace FCA Switchboard
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Location	VA Medical Center, Milwaukee, WI
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Date

Checked By:

Drawn By:

CONSTRUCTION DOCUMENTS



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Building Number
113


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Office of
Facilities
Management






FLOOR PLAN – LOWER LEVEL – TECHNOLOGY 1

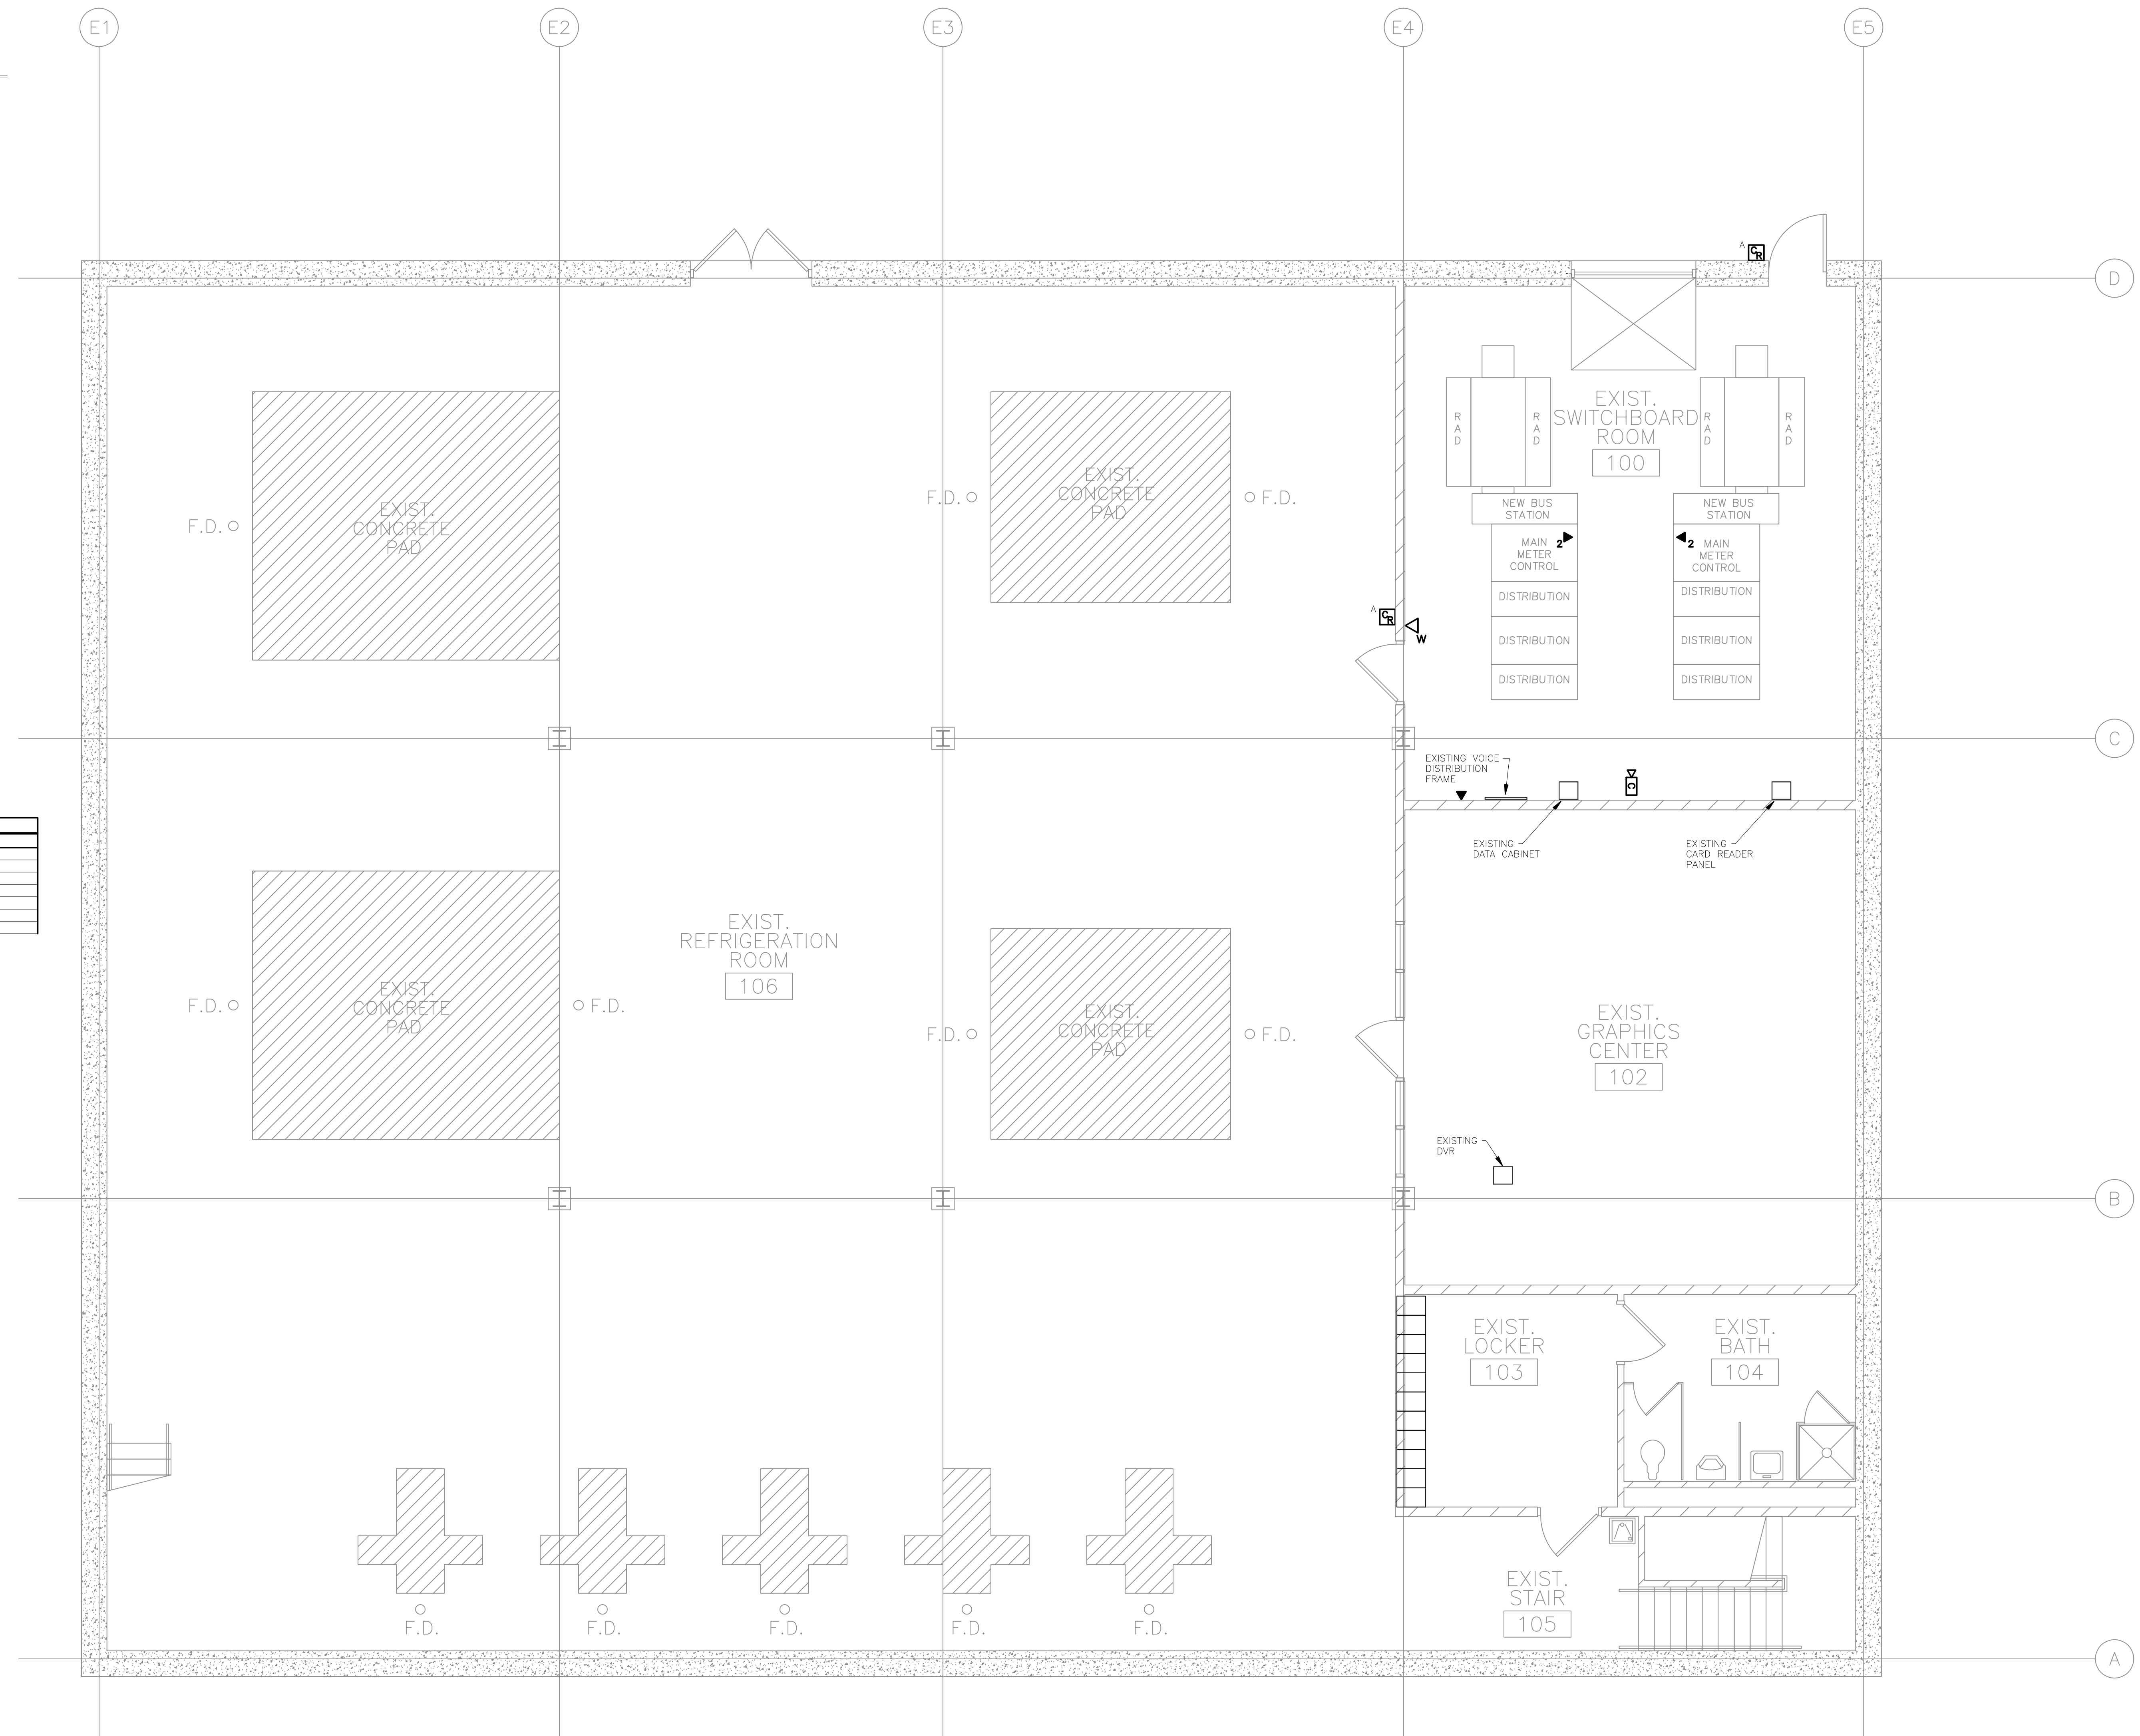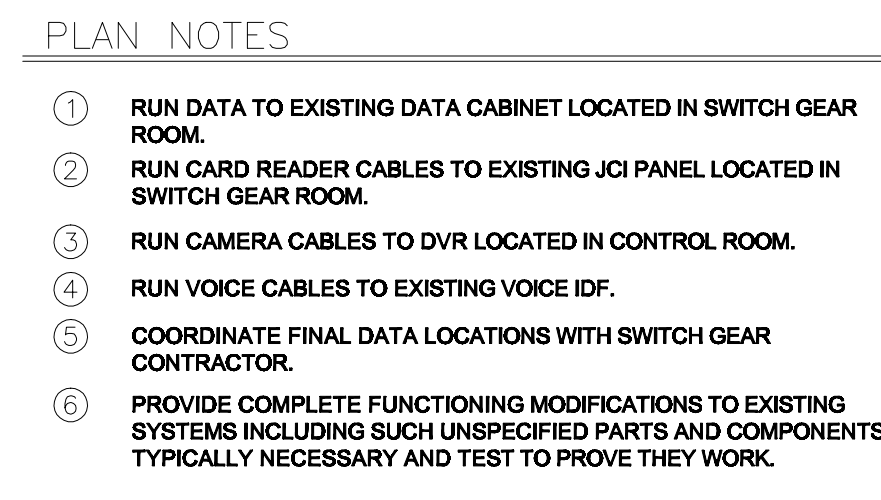

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VERIFY SCALES
BAR BELOW IS 1" ON
ORIGINAL DRAWING

IF NOT 1" ON
REPRODUCTION, ADJUST
SCALES ACCORDINGLY

Location VA Medical Center, Milwaukee, WI		
Date 20 July 2012	Checked By: G+	Drawn By: G+

Drawing Number

Y100

Department of
Veterans Affairs